STAFF REPORT TO: AMADOR COUNTY PLANNING COMMISSION

FOR MEETING OF: OCTOBER 10, 2017

REQUEST FOR A USE PERMIT (UP-17;8-1) TO INSTALL AN 82-FOOT-TALL "BROADLEAF TREE POLE" WIRELESS COMMUNICATION TOWER WITH TWELVE 6-FOOT-TALL PANEL ANTENNAE, TWO 6-FOOT DIAMETER MICROWAVE DISHES, AND ASSOCIATED TOWER AND GROUND EQUIPMENT.

Applicant: Epic Wireless Group, Inc., on behalf of AT&T Mobility, LLC

Property Owner: Joseph John Sr. & Connie Lee Jess Trust

Supervisorial District 2

Location: 5001 Oak Meadow Court, approximately 3,100 feet south of Goose Hill

Ranch Road (APN 012-080-037).


- A. General Plan Designation of Area: A-G, Agricultural-General
- B. Current Zoning: "X," Special Use District
- C. Description: Epic Wireless, Inc., is requesting a Use Permit for the installation of an 82-foot-tall "broadleaf tree pole" design wireless communication tower for the purpose of improving high-speed internet service in the area. The project is part of the FCC's Connect America Fund II program to expand broadband and voice service to underserved areas, and will also be available for expansion of cellular telephone coverage including colocation of future wireless communication equipment. County Code requires a Use Permit for communication towers in excess of 50 feet. The location of the proposed tower is in the southeast corner of the subject parcel, a minimum of 1,300+/- feet from Oak Meadow Court.


Pursuant to County Code Section 19.48.150.G.3 (Wireless Service Facilities – Development Standards), such facilities shall not exceed existing tree lines along a skyline by more than 15 feet. The elevation of the proposed tower base is 650 feet MSL, which would give it an overall height of 732 feet MSL (650 + 82). The ridge on which the tower would be located reaches a height of 720 feet MSL approximately 900 feet from the tower site, and a height of 950 feet MSL at Waters Peak, approximately 4,400 feet from the tower site (elevation map attached). The proposed tower complies with the County Code height limitations.

- D. Staff Review and Recommendation: This project was reviewed by staff, which found no technical objections to the Planning Commission approving the Use Permit subject to the Conditions of Approval and findings attached to the staff report. Staff also recommends the Commission find this project is Categorical Exempt from CEQA per Section 15303(c) of the CEQA guidelines.
- **E. Planning Commission Action:** After taking public comments, a decision to either deny or grant the Use Permit with the proposed conditions (or as amended) can be made.
- F. Findings: If the Planning Commission approves this Use Permit, the following findings

are recommended for adoption:

- 1. The project, as proposed and conditioned, is consistent with the Amador County General Plan and the "X" zoning district at this location; and
- 2. The approval of the Use Permit is sanctioned by County Code Section 19.48.150 (Wireless Service Facilities) and is consistent with County Code Section 19.56.040 (Use Permit Findings) in that the establishment, maintenance or operation of proposed use will not be detrimental to the health, safety, peace, morals, comfort, and general welfare of the persons residing or working in the neighborhood of such proposed use or be detrimental or injurious to property and improvements in the neighborhood or the general welfare of the County; and
- 3. The project is Categorically Exempt from CEQA pursuant to Section and 15303(c) in that it is small project under 2,500 square feet and not involving the use of significant amounts of hazardous materials. Therefore, a Notice of Exemption will be filed with the Amador County Recorder.

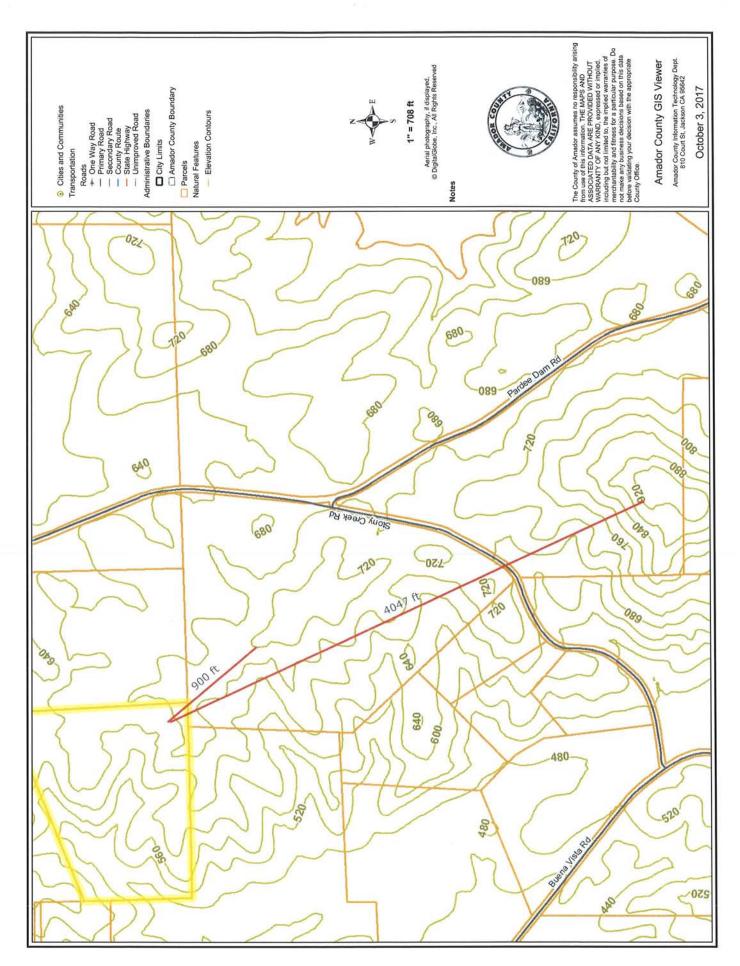

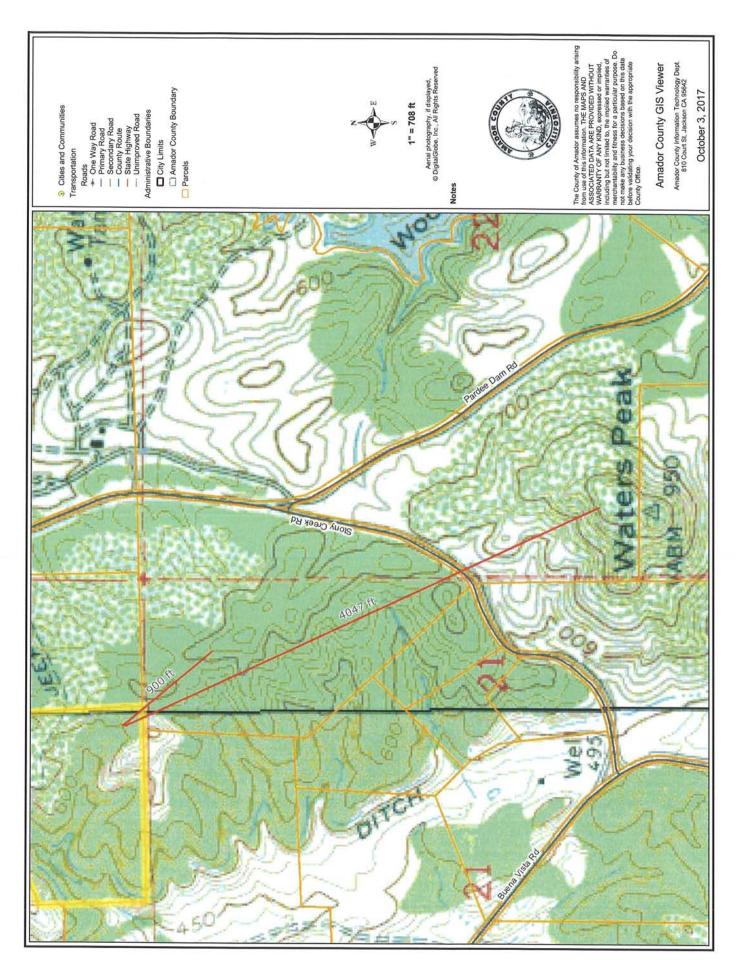



PLANNING DEPARTMENT LAND USE AGENCY

County Administration Center 810 Court Street - Jackson, CA 95642-2132 Telephone: (209) 223-6380

> Website: www.co.amador.ca.us E-mail: planning @amadorgov.org

APPLICATION REFERRAL

TO:

Environmental Health Department

Transportation and Public Works Department

Building Department

Amador Fire Protection District Waste Management/Air District

Surveying Department

County Counsel

Cal Fire

DATE:

September 15, 2017

FROM:

Chuck Beatty, Planner III

PROJECT: Request from Epic Wireless Group for a Use Permit (UP-17:8-1) to allow the construction of an 82-foot-tall wireless communication tower in the "X," Special Use district for the purposes of improving high-speed internet service in the area. Per Amador County Code 19.48.150(E). commercial wireless service facilities with a height greater than 50 feet are subject to a Use Permit issued by the Planning Commission.

LOCATION: 5001 Oak Meadow Court, Ione, approximately 0.60 miles south of Goose Hill Ranch Road in the Buena Vista area (APN 012-080-037)

REVIEW:

As part of the preliminary review process, this project is being sent to local agencies for their review and comment. At this time, the project is being processed as Categorically Exempt from CEQA and a Notice of Exemption will be adopted per CEQA Guidelines.

If you have comments or recommended conditions for this project, please forward them to the Planning Department by Wednesday, September 27, 2017.



Date: 8/25/17

RE: Proposed AT&T Wireless Site "Camp Pardee"

APN: 012-080-037-000

To Whom It May Concern:

The purpose of this application is to obtain a conditional use permit for a proposed 82' wireless facility. The primary objective of this facility is to fulfill the objectives of the FCC's CAF II project and bring high speed internet to underserved communities. As a secondary purpose, this facility will also help improve the wireless coverage and capacity in this area.

Please let me know if you have any questions or would like more details about this or any other CAF II projects.

Respectfully,

Stephanie Dowdle Leasing/Planning Manager

> 8700 Auburn Folsom Road, Suite 400 Granite Bay, CA. 95746 Fax (916) 781-5927

APPLICATION PROCEDURE FOR USE PERMIT

A Public Hearing before the Planning Commission will be scheduled after the following information has been completed and submitted to the Planning Department Office:

1.	Complete the following:	Y .			
Name	of Applicant ATT No Esic Wi	reless			
Mailin	g Address 8 700 Aubum Falson	Rd, Suite 90	٥		
Phone	Number _				
Asses	sor Parcel Number 012 - 080 -0	037			
		I Plan Designation_			
	Use Permit Applied For: Excessive Height Sea Land Container Bed and Breakfast Inn Sign Program Other Wick S				
3.	Attach a letter explaining the purpose	and need for the Us	e Permit.		
4.	If Applicant is not the property owner.				
5.	Attach a copy of the deed for the prop County Recorder's Office).	erty (can be obtaine	d from the		
6.	Assessor Plat Map (can be obtained fr	rom the County Surv	eyor's Office).		
7.	7. Plot Plan (no larger than 11" X 17") of parcel showing location of request in relation to property lines, road easements, other structures, etc. (see Plot Plan Guidelines). Larger map(s) or plans may be submitted if a photoreduction is provided for notices, Staff Reports, etc. The need is for easy mass reproduction.				
8.	Planning Department Filing Fee:	\$			
-	Public Works Agency Review Fee:	\$	Rep. Initials		
(<u></u>	Environmental Health Review Fee:	\$	Rep. Initials		
::	Amador Fire Protection District Fee:	\$	Rep. Initials		
	If necessary, complete an Environmer Department Staff).				
** Public W	orks Agency, Environmental Health D	epartment, and Am	ador Fire		

G:\PLAN\WPDOCS\Forms\UP Application - CE.doc

Protection Fees apply.

LETTER OF AUTHORIZATION TO FILE PERMIT APPLICATIONS

Re: Amador County

To Whom It May Concern:

The undersigned, Landlord, is the owner of the property located at 5001 Oak Meadow Court, Ione, CA 95640, County Assessor's Parcel No. <u>012-080-037-000</u>, that is the subject of a Land Use application for a new AT&T Mobility Telecommunications Facility. The undersigned, Landlord, authorizes AT&T Mobility, C/O Epic Wirelss Group, and hereby authorizes Epic Wireless Group, its agent, to act as applicant to obtain any and all permits required for the approval and construction of this antenna/communication facility.

Landlord/Lessor:

Landlord

Date

S

S

ALL 16, T.5N., R.10E., M.D.B.

POR. SEC. 15,

Ç.III

(g)

14

(7/6/2001)



Radio Frequency Emissions Compliance Report For AT&T Mobility

Site Name:

Camp Pardee

Site Structure Type: Monopine

38.268558

Address:

5001 Oak Meadow Court

Latitude:

Ione, CA

Longitude:

-120.882439

Report Date: June 29, 2017

Project:

New Build

General Summary

AT&T Mobility has contracted Waterford Consultants, LLC to conduct a Radio Frequency Electromagnetic Compliance assessment of the proposed Camp Pardee site located at 5001 Oak Meadow Court, Ione, CA. This report contains information about the radio telecommunications equipment to be installed at this site and the surrounding environment with regard to RF Hazard compliance. This assessment is based on installation designs and operational parameters provided by AT&T Mobility.

The compliance framework is derived from the Federal Communications Commission (FCC) Rules and Regulations for preventing human exposure in excess of the applicable Maximum Permissible Exposure ("MPE") limits. At any location at this site, the power density resulting from each transmitter may be expressed as a percentage of the frequency-specific limits and added to determine if 100% of the exposure limit has been exceeded. The FCC Rules define two tiers of permissible exposure differentiated by the situation in which the exposure takes place and/or the status of the individuals who are subject to exposure. General Population / Uncontrolled exposure limits apply to those situations in which persons may not be aware of the presence of electromagnetic energy, where exposure is not employment-related, or where persons cannot exercise control over their exposure. Occupational / Controlled exposure limits apply to situations in which persons are exposed as a consequence of their employment, have been made fully aware of the potential for exposure, and can exercise control over their exposure. Based on the criteria for these classifications, the FCC General Population limit is considered to be a level that is safe for continuous exposure time. The FCC General Population limit is 5 times more restrictive than the Occupational limits.

	Limits for General Populat	ion/ Uncontrolled Exposure	Limits for Occupational/ Controlled Expe		
Frequency (MHz)	Power Density (mW/cm²)	Averaging Time (minutes)	Power Density (mW/cm²)	Averaging Time (minutes)	
30-300	0.2	30	1	6	
300-1500	f/1500	30	f/300	6	
1500-100,000	1.0	30	5.0	6	

f=Frequency (MHz)

In situations where the predicted MPE exceeds the General Population threshold in an accessible area as a result of emissions from multiple transmitters, FCC licensees that contribute greater than 5% of the aggregate MPE share responsibility for mitigation.

Based on the computational guidelines set forth in FCC OET Bulletin 65, Waterford Consultants, LLC has developed software to predict the overall Maximum Permissible Exposure possible at any particular location given the spatial orientation and operating parameters of multiple RF sources. These theoretical results represent worst-case predictions as emitters are assumed to be operating at 100% duty cycle.

For any area in excess of 100% General Population MPE, access controls with appropriate RF alerting signage must be put in place and maintained to restrict access to authorized personnel. Signage must be posted to be visible upon approach from any direction to provide notification of potential conditions within these areas. Subject to other site security requirements, occupational personnel should be trained in RF safety and equipped with personal protective equipment (e.g. RF personal monitor) designed for safe work in the vicinity of RF emitters. Controls such as physical barriers to entry imposed by locked doors, hatches and ladders or other access control mechanisms may be supplemented by alarms that alert the individual and notify site management of a breach in access control. Waterford Consultants, LLC recommends that any work activity in these designated areas or in front of any transmitting antennas be coordinated with all wireless tenants.

Analysis

AT&T Mobility proposes the following installation at this location:

- Install twelve (12) new panel antennas
- Install eighteen (18) new RRUS

The antennas will be mounted on a 82-foot Monopine with centerlines at 60 feet above ground level. The antennas will be oriented toward 90, 330 and 210 degrees. The Effective Radiated Power (ERP) in any direction from all AT&T Mobility operations will not exceed 20,229 Watts. Other appurtenances such as GPS antennas, RRUs and hybrid cable are not sources of RF emissions. From this site, AT&T Mobility will enhance voice and data services to surrounding areas in licensed 700, 850, 1900, 2100 and 2300 MHz bands. No other antennas are known to be operating in the vicinity of this site.

Power density decreases significantly with distance from any antenna. The panel-type antennas to be employed at this site are highly directional by design and the orientation in azimuth and mounting elevation, as documented, serve to reduce the potential to exceed MPE limits at any location other than directly in front of the antennas. For accessible areas at ground level, the maximum predicted power density level resulting from all AT&T Mobility operations is 2.4305% of the FCC General Population limits. Incident at adjacent buildings depicted in Figure 1, the maximum predicted power density level resulting from all AT&T Mobility operations is 0.7095% of the FCC General Population limits. The proposed operation will not expose members of the General Public to hazardous levels of RF energy and will not contribute to existing cumulative MPE levels on walkable surfaces at ground or at adjacent buildings by 5% of the General Population limits.

Waterford Consultants, LLC recommends posting contact information signage at the gate that informs personnel entering the site of basic precautions to be followed when working around antennas. RF alerting signage (Caution) should be posted at the base of the proposed Monopine to inform authorized climbers of potential conditions near the antennas. These recommendations are depicted in Figure 2.

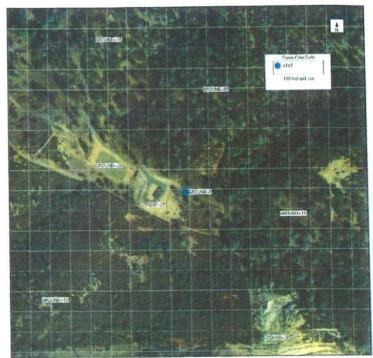


Figure 1: Antenna Locations

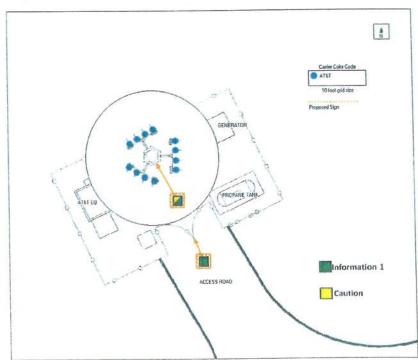


Figure 2: Mitigation Recommendations

Page 3
Waterford Consultants, LLC • 201 Loudoun Street Southeast Suite 300 • Leesburg, Virginia 20175 • 703.596.1022

Compliance Statement

Based on information provided by AT&T Mobility and predictive modeling, the installation proposed by AT&T Mobility at 5001 Oak Meadow Court, Ione, CA will be compliant with Radiofrequency Radiation Exposure Limits of 47 C.F.R. § 1.1307(b)(3) and 1.1310. RF alerting signage and restricting access to the Monopine to authorized climbers that have completed RF safety training is required for Occupational environment compliance.

Certification

I, David H. Kiser, am the reviewer and approver of this report and am fully aware of and familiar with the Rules and Regulations of both the Federal Communications Commissions (FCC) and the Occupational Safety and Health Administration (OSHA) with regard to Human Exposure to Radio Frequency Radiation, specifically in accordance with FCC's OET Bulletin 65. I have reviewed this Radio Frequency Exposure Assessment report and believe it to be both true and accurate to the best of my knowledge.

H. Kiser, P. E. 2017.07.11 13:18:09 -04'00'

Page 4


Alternative Site Analysis

AT&T Telecommunications and Internet Facility "Camp Pardee"

5001 Oak Meadow Court Ione, CA 95640

August 25, 2017

Summary of Site Evaluations and Technical Evidence Conducted by Epic Wireless Group, Inc.

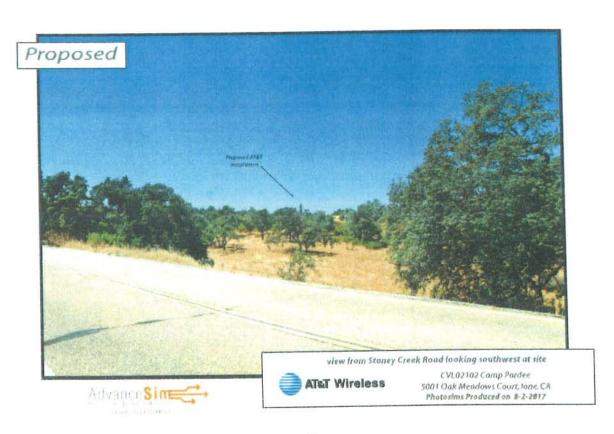

I. Executive Summary

In the summer of 2016, Epic Wireless Group LLC was contracted by AT&T to identify a wireless site location and design to provide high speed internet for the FCC's Connect America Fund II project and improve the wireless coverage and capacity in the area. After conducting thorough research and evaluation of existing properties and structures in the area that would accommodate a collocation, AT&T determined a new tower must be constructed to adequately meet the internet service goals and wireless coverage and capacity goals. Epic Wireless investigated a total of 4 potential alternatives and concluded that the presently proposed 82' lattice tower located on Oak Meadow Court is the least intrusive site that can offer the required internet service and wireless coverage to this area. This report walks through each alternative and the various obstacles associated with each site.

II. Coverage Objective


The FCC has determined that this is an area with insufficient internet service. As a result, this area was included in the FCC's Connect America Fund – II project. This purpose of this project is to bring high speed internet to underserved communities. This is measured by the number of living units that will be serviced by the facility. This particular project requires line-of-sight to serve the maximum number of living units. In addition to improving the internet service, AT&T will also provide improved wireless coverage.

III. Methodology


In identifying the least intrusive site location and design, AT&T looks to topography, local code, ordinances, and general plans to identify the values significant to the local community for placement of wireless facilities. In addition, each proposed site must meet minimum requirements of fulfilling living units and coverage objectives, a willing landlord, feasible construction, road access, available telephone and electrical utilities as well as compliance with local zoning requirements.

Epic Wireless first attempted to identify existing cell towers for collocation. No existing cell towers were identified in the immediate area. A minimum antenna centerline of 72' at a high elevation is required to reach as many living units as possible with the internet and wireless service. As such, a new monopine was proposed.

IV. Candidates Investigated

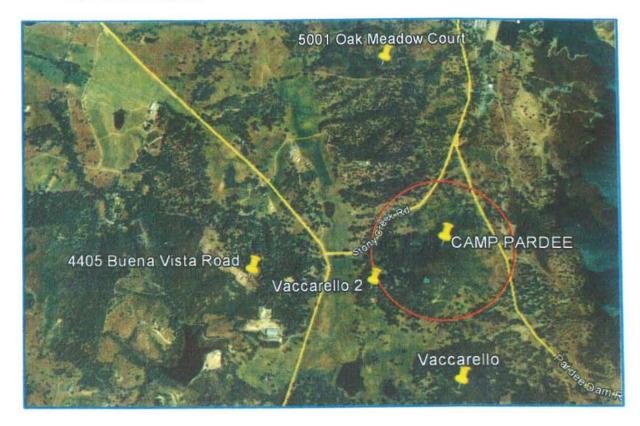


1. Vaccarello APN: 012-140-004-000

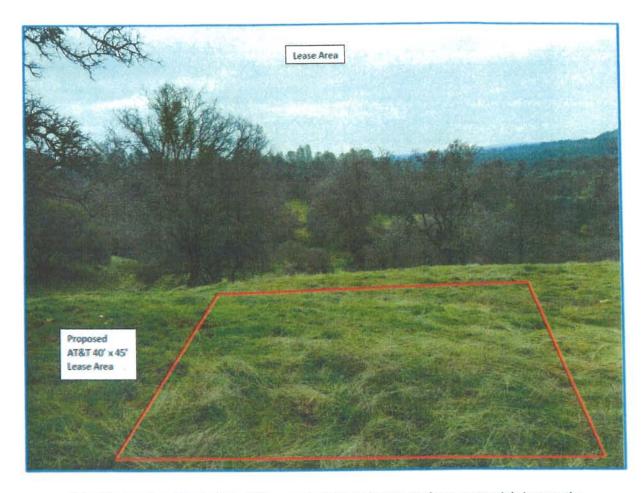

Epic Wireless investigated this 300 acre property and presented two potential sites on the parcel to AT&T as candidates. This site is at the southern end of the property near some power poles on a hill. While AT&T was interested in this location, the property owner ultimately decided that he was not interested in having a wireless facility on his property.

2. Vaccarello 2 APN: 012-140-004-000

Epic Wireless looked into this location as it was closest to the center of the search ring. Ultimately, AT&T did not move forward with this site because the property owner decided that he was not interested in having a wireless facility on his property.

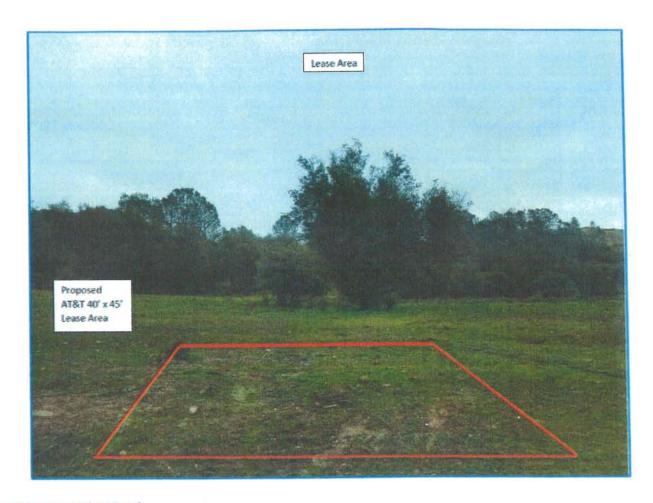

3. 4405 Buena Vista Road

Epic Wireless walked this property with the property owner's representative. The radio frequency engineer determined that this site would not fulfill AT&T's objectives because of its location outside of the ring and its low elevation. The elevation of this site is approximately 526'. For comparison, the chosen candidate is at an elevation of 684'.

IV. Conclusion

The identified site location and design of the proposed facility represents a thorough and responsible investigation of alternative site locations. AT&T, with the help of Epic Wireless and AT&T Wireless RF Engineers, has determined the proposed site to be the least intrusive means to service maximum number of living units. This facility is believed to have the least impacts to the community while offering future opportunity for other carriers to collocate.



SITE NUMBER: CVL02102 atat SITE NAME: CAMP PARDEE 5001 OAK MEADOWS CT

IONE. CA 95640

PROJECT INFORMATION PROJECT TEAM SHEET INDEX TITLE SHEET SITE NAME: SITE NUMBER: FA LOCATION#: GN-1 GENERAL NOTES GN-2 C-1 C-2 C-3 SITE SIGNAGE ENGINEERING FIRM: PEEK SITE-COM 12852 EARHART AVE SUITE 101 AUBURN, CA 95602 (530) 885-6160 SITE SURVEY SITE ADDRESS: CONSTRUCTION MANAGER: SITE SURVEY EROSION CONTROL PLAN & DETAILS GRADING NOTES & DETAILS EPIC WRELESS C-4 8700 AUBURN FOLSOM ROAD, SUITE 400 ASSESSORS PARCEL NUMBER: A-1 OVERALL SITE PLAN GRANITE BAY, CA 95746 (530) 383-5957 SITE ACQUISITION & PLANNING: STEPHANIE DOWDLE LONGITUDE: A-2 EQUIPMENT PLAN STEPTANIE DOWNLE EPIC WRELESS 8700 AUBURN FOLSOM ROAD, SUITE 400 GRANITE BAY, CA 95746 A-3 ANTENNA PLAN & DETAILS AMADOR COUNTY A-4 **ELEVATIONS** 1226 HIGH STREET AUBURN, CA 95603 (530) 885-0426 **ELEVATIONS** (916) 936-5430 JOSEPH JOHN SR. & CONNIE LEE JESS TRUST 5001 OAK MEADOWS CT. IONE , CA 95640 PROPERTY OWNER: CIVIL VENDOR: VINCULUMS CONSTRUCTION MANAGER KEN ABEL KABEL ØVINCULUMS.COM (916) 844-4602 OWNER ADDRESS: TELEPHONE AGENCY: CODE COMPLIANCE VICINITY MAP DIRECTIONS FROM AT&T PROJECT DESCRIPTION ALL WORK AND MATERIALS SHALL BE PERFORMED AND INSTALLED IN DIRECTIONS FROM AT&T'S OFFICE AT 2600 CAMINO RAMON, SAN RAMON, CA AT&T PROPOSES TO CONSTRUCT A NEW UNMANNED TELECOMMUNICATIONS FACILITY. AT&T WILL INSTALL: ACCORDANCE WITH THE CURRENT EDITIONS OF THE FOLLOWING CODES AS ADOPTED BY THE LOCAL GOVERNING AUTHORITIES. NOTHING IN THESE PLANS IS TO BE CONSTRUED TO PERMIT WORK NOT CONFORMING TO THESE CODES. NEW 15' WIDE GRAVEL ACCESS ROAD (1) NEW 40'X45' LEASE AREA 1. 2016 CALIFORNIA BUILDING CODE USE THE RIGHT 2 LANES TO EXIT 30B TO MERGE ONTO I-580 E TOWARD STOCKTON NEW 6' CHAIN LINK FENCE 2016 CALIFORNIA FIRE CODE NEW 12' WIDE DOUBLE ACCESS GATE 3. 2016 CALIFORNIA FLECTRICAL CODE KEEP LEFT TO CONTINUE ON 1-205 E, FOLLOW SIGNS FOR INTERSTATE 2016 CALIFORNIA PLUMBING CODE NEW 82' BROADLEAF POLE 205/TRACY/STOCKTON NEW PRE-FAB "MC" LIGHT WEIGHT EQUIPMENT SHELTER WITH 2016 CALIFORNIA MECHANICAL CODE 6. 2016 CALIFORNIA HEALTH AND SAFETY CODE ANCILLARY INTERIOR EQUIPMENT USE THE RIGHT LANE TO TAKE THE CA-4 EXIT TOWARD DOWNTOWN STOCKTON (1) NEW GPS ANTENNA STOCKTON KEEP LEFT AND MERGE ONTO CA-4 USE THE LEFT 2 LANES TO TAKE EXIT 68B TO MERGE ONTO CA-99 N NEW 35KW PROPANE GENERATOR (1) IP PROPANE TANK (500 GALLON) TOWARD SACRAMENTO (12) NEW ANTENNAS TAKE EXIT 255 FOR CA-88/ WATERLOO ROAD TOWARD JACKSON (9) NEW RRUS-11, (9) NEW RRUS-32 & (3) FUTURE RRUS CONTINUE ON CA-88E DRIVE TO OAK MEADOWS CT. IN AMADOR COUNTY TURN RIGHT ONTO CA-88E (4) NEW SURGE SUPPRESSORS NEW 6' M/W DISH TURN LEFT TO STAY ON CA-88E (1) FUTURE 6' M/W DISH 12. TURN RIGHT ONTO JACKSON VALLEY RD / OLD VALLEY 13. TURN RIGHT ONTO GOOSE HILL RANCH RD 14. GOOSE HILL RANCH RD TURNS RIGHT AND BECOMES OAK MEADOWS CT. SITE LOCATION OCCUPANCY & CONST. TYPE SPECIAL INSPECTIONS APPROVALS APPROVED BY: INITIALS: *SEE SPECIAL INSPECTION FORM OCCUPANCY: U (UNMANNED) AT&T: POST-INSTALLED ANCHORS HIGH STRENGTH BOLTING CONSTRUCTION TYPE: V-B GENERAL CONTRACTOR NOTES VENDOR: R.F.: DO NOT SCALE DRAWINGS LEASING/LANDLORD: THESE DRAWINGS ARE FORMATTED TO BE FULL SIZE 24"X36". CONTRACTOR SHALL VERIFY ALL PLANS AND EXISTING DIMENSIONS AND CONDITIONS ON THE JOBSITE ZONING: AND SHALL IMMEDIATELY NOTIFY THE ARCHITECT/ENGINEER CONSTRUCTION: ACCESSIBILITY REQUIREMENTS: THIS FACILITY IS UNMANNED AND NOT FOR HUMAN HABITATION, HANDICAPPED IN WRITING OF ANY DISCREPANCIES BEFORE PROCEEDING WITH THE WORK OR MATERIAL ORDERS OR BE POWER/TELCO: ACCESS REQUIREMENTS ARE NOT REQUIRED IN ACCORDANCE WITH THE 2016 CALIFORNIA BUILDING CODE, CHAPTER 11B, EXCEPTION SECTION 11B-203.5 RESPONSIBLE FOR THE SAME

PG&F

PROPRIETARY INFORMATION

HE INFORMATION CONTAINED IN THIS SET OF DRAWINGS IS PROPRIETARY
BY NATURE. ANY USE OR
DISCLOSURE OTHER THAN THAT WHICH
RELATES TO PEEK SITE-COM IS
STRICTLY PROHIBITED

CLIENT: ==



5001 EXECUTIVE PKWY SAN RAMON, CA 94583

PROJECT INFORMATION:

CAMP PADREE

5001 OAK MEADOWS CT.

SEA:	= DATE: ===	DESCRIPTION:	BY
1	5-22-17	90% ZONING DOC'S	ALP
2	6-6-17	90% ZONING DOC'S	ALP
3	8-24-17	100% ZONING DOC'S	TAP
4	9-19-17	REV 100% ZONING DOC'S	RB
_			-
			1
_			_
			+

Peek Site-Com

12852 Earhart Ave. Suite 101 Auburn, California 95602 Phone (530) 885-6160

COORDINATING ENGINEER:=

E-Mail info@peeksitecom.com



= DRAWN BY: = CVL02102 ALP

SHEET TITLE: =

TITLE SHEET

SHFFT NUMBER:

== REVISION:=

GENERAL CONSTRUCTION NOTES:

- DRAWINGS ARE NOT TO BE SCALED, WRITTEN DIMENSIONS TAKE PRECEDENCE, AND THIS SET OF PLANS IS INTENDED TO BE USED FOR DIAGRAMMATIC PURPOSES ONLY, UNLESS NOTED OTHERWISE. THE GENERAL CONTRACTOR'S SCOPE OF WORK SHALL INCLUDE FURNISHING ALL MATERIALS, EQUIPMENT, LABOR, AND ANYTHING ELSE DEEMED NECESSARY TO COMPLETE INSTALLATIONS AS DESCRIBED HEREIN
- 2. PRIOR TO THE SUBMISSION OF BIDS, THE CONTRACTORS INVOLVED SHALL VISIT THE JOB SITE AND FAMILIARIZE THEMSELVES WITH ALL CONDITIONS AFFECTING THE PROPOSED PROJECT, WITH THE CONSTRUCTION AND CONTRACT DOCUMENTS, FIELD CONDITIONS AND CONFIRM THAT THE PROJECT MAY BE ACCOMPLISHED AS SHOWN PRIOR TO PROCEEDING WITH CONSTRUCTION. ANY ERRORS, OMISSIONS, OR DISCREPANCIES ARE TO BE BROUGHT TO THE ATTENTION OF THE ARCHITECT/ENGINEER.
- 3. THE GENERAL CONTRACTOR SHALL RECEIVE WRITTEN AUTHORIZATION TO PROCEED WITH CONSTRUCTION PRIOR TO STARTING WORK ON ANY ITEM NOT CLEARLY DEFINED BY THE CONSTRUCTION DRAWINGS/
- 4. THE CONTRACTOR SHALL SUPERVISE AND DIRECT THE PROJECT DESCRIBED HEREIN. THE CONTRACTOR PROCEDURES AND FOR COORDINATING ALL PORTIONS OF THE WORK UNDER THE CONTRACTOR AND PROCEDURES AND FOR COORDINATING ALL PORTIONS OF THE WORK UNDER THE CONTRACT.
- 5. THE CONTRACTOR SHALL INSTALL ALL EQUIPMENT AND MATERIALS ACCORDING TO MANUFACTURER'S/ VENDOR'S SPECIFICATIONS UNLESS NOTED OTHERWISE OR WHERE LOCAL CODES OR ORDINANCES TAKE
- 6. ALL WORK PERFORMED ON PROJECT AND MATERIALS INSTALLED SHALL BE IN STRICT ACCORDANCE WITH ALL APPLICABLE CODES, REGULATIONS, AND ORDINANCES. CONTRACTOR SHALL GIVE ALL NOTICES AND COMPLY WITH ALL LAWS, ORDINANCES, RULES, REGULATIONS AND LAWFUL ORDERS OF ANY PUBLIC
- AUTHORITY, MUNICIPAL AND UTILITY COMPANY SPECIFICATIONS, AND LOCAL AND STATE JURISDICTIONAL CODES BEARING ON THE PERFORMANCE OF THE WORK.


 GENERAL CONTRACTOR SHALL PROVIDE AT THE PROJECT SITE A FULL SET OF CONSTRUCTION DOCUMENTS UPDATED WITH THE LATEST REVISIONS AND ADDENDUMS OR CLARIFICATIONS FOR THE USE BY ALL PERSONNEL INVOLVED WITH THE PROJECT.
- 8. THE STRUCTURAL COMPONENTS OF THIS PROJECT SITE/ FACILITY ARE NOT TO BE ALTERED BY THIS
- CONSTRUCTION PROJECT UNLESS NOTED OTHERWISE.

 9. DETAILS INCLUDED HEREIN ARE INTENDED TO SHOW END RESULT OF DESIGN, MINOR MODIFICATIONS MAY REQUIRED TO SUIT JOB CONDITIONS OR SITUATIONS, AND SUCH MODIFICATIONS SHALL BE INCLUDED AS PART OF THE SCOPE OF WORK.
- 10. SEAL PENETRATIONS THROUGH FIRE-RATED AREAS WITH U.L. LISTED OR FIRE MARSHALL APPROVED MATERIALS IF APPLICABLE TO THIS FACILITY AND OR PROJECT SITE.
- 11. PROVIDE A PORTABLE FIRE EXTINGUISHER WITH A RATING OF NOT LESS THAN 2-A OR 2-A10BC WITHIN 75 FEET TRAVEL DISTANCE TO ALL PORTIONS OF THE PROJECT AREA DURING CONSTRUCTION.
- THE CONTRACTOR SHALL MAKE NECESSARY PROVISIONS TO PROTECT EXISTING IMPROVEMENTS, EASEMENTS, PAVING, CURBING, ETC. DURING CONSTRUCTION, UPON COMPLETION OF WORK, CONTRACTOR SHALL REPAIR ANY DAMAGE THAT MAY HAVE OCCURRED DUE TO CONSTRUCTION ON OR ABOUT THE PROPERTY.
- 13. CONTRACTOR SHALL SEE TO IT THAT GENERAL WORK AREA IS KEPT CLEAN AND HAZARD FREE DURING CONSTRUCTION AND DISPOSE OF ALL DIRT, DEBRIS, RUBBISH AND REMOVE EQUIPMENT NOT SPECIFIED AS REMAINING ON THE PROPERTY. PREMISES SHALL BE LEFT IN CLEAN CONDITION AND FREE FROM PAINT SPOTS, DUST, OR SMUDGES OF ANY NATURE.
- 14. THE ARCHITECTS/ENGINEERS HAVE MADE EVERY EFFORT TO SET FORTH IN THE CONSTRUCTION AND CONTRACT DOCUMENTS THE COMPLETE SCOPE OF WORK. CONTRACTORS BIDDING THE JOB ARE NEVERTHELESS CAUTIONED THAT MINOR OMISSIONS OR ERRORS IN THE DRAWINGS AND OR SPECIFICATIONS SHALL NOT EXCUSE SAID CONTRACTOR FROM COMPLETING THE PROJECT AND IMPROVEMENTS IN ACCORDANCE WITH THE INTENT OF THESE DOCUMENTS. THE BIDDER SHALL BEAR THE RESPONSIBILITY OF NOTIFYING (IN WRITING) THE ARCHITECT/ENGINEER OF ANY CONFLICTS, ERRORS, OR OMISSIONS PRIOR TO THE SUBMISSION OF CONTRACTOR'S PROPOSAL. IN THE EVENT OF DISCREPANCIES THE CONTRACTOR SHALL PRICE THE MORE COSTLY OR EXTENSIVE WORK, UNLESS DIRECTED OTHERWISE.

ABBREVIATIONS

ABV.	ABOVE	L.F.	LINEAR FEET (FOOT)
ADD'L	ADDITIONAL	MAX.	MAXIMUM
A.G.L.	ABOVE GROUND LEVEL	M.B.	MACHINE BOLT
ALUM.	ALUMINUM	MECH.	MECHANICAL
APPROX.	APPROXIMATELY	MFR.	MANUFACTURER
AWG.	AMERICAN WIRE GAUGE	MIN.	MINIMUM
BLDG.	BUILDING	MISC.	MISCELLANEOUS
BLK.	BLOCKING	MTL	METAL
CAB.	CABINET	(N)	NEW
CONC.	CONCRETE	NO. (#)	NUMBER
CONN.	CONNECTION(OR)	N.T.S.	NOT TO SCALE
CONST.	CONSTRUCTION	0.C.	ON CENTER
CONT.	CONTINUOUS		
DBL.	DOUBLE	P/C	PRECAST CONCRETE
DEPT.	DEPARTMENT	PPC	POWER PROTECTION CABINET
D.F.	DOUGLAS FIR	P.S.F.	POUNDS PER SQUARE FOOT
DIA.	DIAMETER	P.S.I.	POUNDS PER SQUARE INCH
DIM.	DIMENSION	P.T.	PRESSURE TREATED
EA.	EACH	QTY.	QUANTITY
EL.	ELEVATION	RAD. (R)	
ELEC.	ELECTRICAL	REF.	REFERENCE
EMT.	ELECTRICAL METALLIC TUBING	REINF.	REINFORCEMENT(ING)
ENG.	ENGINEER	REQ.'D	REQUIRED
EQ.	EQUAL	RGS	RIGID GALVANIZED STEEL
		SCH.	SCHEDULE
(E)	EXISTING	SHT.	SHEET
EXT.	EXTERIOR	SPEC.	SPECIFICATIONS
FAB.	FABRICATION	SQ.	SQUARE
F.A.	FINISHED FLOOR	S.S.	STAINLESS STEEL
F.B	FINISHED GRADE	STD.	STANDARD
FT. (')	FOOT (FEET)	STL.	STEEL
FTG.	FOOTING	STRUC.	
GA.	GAUGE	TEMP.	TEMPORARY
GALV.	GALVANIZE(D)	T.O.A.	TOP OF ANTENNAS
G.F.I.	GROUND FAULT CIRCUIT INTERRUPTER	T.O.F.	TOP OF FOUNDATION
GPS	GLOBAL POSITIONING SYSTEM	T.O.P.	TOP OF PLATE (PARAPET)
GRND.	GROUND(ING)	T.O.W.	TOP OF WALL
HT.	HEIGHT	TYP.	TYPICAL
ICGB.	ISOLATED COPPER GROUND BUS	U/G	UNDER GROUND
IN. (")	INCH(ES)	V.I.F.	VERIFY IN FIELD
INT.	INTERIOR	W.I.F.	
L.B.	LAG BOLTS		WIDE (WIDTH)
		W/	WITH
		WT.	WEIGHT

SYMBOLS LEGEND

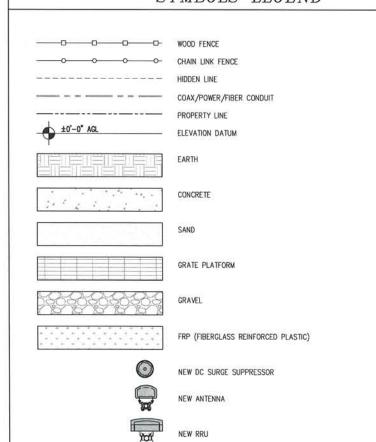

PROPRIETARY INFORMATION

HE INFORMATION CONTAINED IN THIS SET OF DRAWINGS IS PROPRIETARY
BY NATURE. ANY USE OR
DISCLOSURE OTHER THAN THAT WHICH
RELATES TO PEEK SITE-COM IS
STRICTLY PROHIBITED

CLIENT: ===



5001 EXECUTIVE PKWY SAN RAMON, CA 94583

PROJECT INFORMATION:

CAMP PADREE

5001 OAK MEADOWS CT. IONE , CA 95640

REV:	= DATE: ===	DESCRIPTION:	BY:
1	5-22-17	90% ZONING DOC'S	ALP
2	6-6-17	90% ZONING DOC'S	ALP
3	8-24-17	100% ZONING DOC'S	TAP
4	9-19-17	REV 100% ZONING DOC'S	RB
			+-
H			-
_			_
_			_
1			

COORDINATING ENGINEER:

Peek Site-Com

12852 Earhart Ave. Suite 101 Auburn, California 95602 Phone (530) 885-6160

E-Mail info@peeksitecom.com



CHK.: DRAWN BY: CVL02102 ALP

GENERAL NOTES

SHEET NUMBER:

SHEET TITLE:




This Site Operated by.

AT&T MOBILITY 2600 CAMINO RAMON, 4W850 N SAN RAMON, CA 94583 IN CASE OF FIRE AND THE NEED FOR SHUTDOWN TO DEACTIVATE ANTENNAS CALL THE FOLLOWING NUMBER: For 24 Hour Emergency Contact and Access Please Call: (800) 832-6662

Reference Site#: CVL02102 Site Address: 5001 OAK MEADOWS CT. IONE, CA 95640

FENCED COMPOUND SIGNAGE

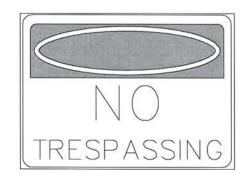

1. CONTRACTOR SHALL RISTALL ALL INFORMATION SIGNAGE IN ACCORDANCE W/ AT&T
WRELESS DOCUMENT \$03-0074, RF EXPOSURE POLICY AND RF SAFETY COMPLIANCE PROGRAM, *SIGN 1-2 POLE, SEE DETAIL 1B, THIS SHEET.

FABRICATION:

INFORMATION

ATET MOBILITY OPERATES TELECOMMUNICATION ANTENNAS AT THIS LOCATION. FEMAN AT LEAST 3 FEET AWAY FROM ANY ANTENNA AND OREY ALL POSITIOS SCORE.

CONTACT THE OWNER(S) OF THE ANTENNAS(S) BEFORE WORKING CLOSER THAN 3 FEET FROM THE ANTENNAS(S)

CONTACT AT&T MOBILITY AT 800-368-2822 PROR TO PERFORMING ANY MAINTENANCE OR REPAIRS NEAR AT&T MOBILITY ANTENNAS.

CONTACT THE MANAGEMENT OFFICE IF THIS DOOR, MATCH/GATE IS FOUND UNLOCKED.

INFORMACION

EN ESTA PROPIEDAD SE UBICAN ANTENAS DE TELECOMANICACIONES OPERADAS POR ATAT. FANOR MANTENER UNA DISTANCIA DE NO MENOS DE 3 PRIS Y OREDICAR TODOS LOS AMBOS.

COMUNIQUESE CON EL PROPIETARIO O LOS PROPIETARIOS DE LAS ANTENAS ANTES DE TRABAJAR O CAMINAR DE MENOS DE 3 PIES DE LA ANTENA

FAVOR COMMUCARSE COM LA OFICINA DE LA ADMINISTRACIÓN DE EXPLOS SI ESTA PUENTA O COMPUERTA SE ENCUENTRA SIN

INFORMATION SIGN 1-1

COMMINIQUESE CON ATAT MOBILITY 800-638-2822 ANTES DE REALIZAR CUALQUER MANTONMENTO O REPARADON DE LAS ANTENAS DE ATAT MOBILITY,

ESTA ES LA ESTACION BASE MIMERO CHINDRO

*SIGN I-1: ENTRANCE DOOR, SEE DETAIL 1A, THIS SHEET SIGN 1 IS TO BE MADE ON THE 50 MIL ALUMINUM SHEETING (SIZE 8 INCHES BY 12 INCHES) W/ (4) 1/4 INCH MOUNTING HOLES. ONE EACH CORNER OF THE SIGN FOR MOUNTING N/ HARDWARE W/ TIE WRAPS. THE MAIN BACKGROUND COLOR IS THE BE WHITE FRONT &

THE INFORMATION BAND SHALL BE 1.2 INCH SOLID GREEN BAND W/ 0.5 INCH HIGH BLACK LETTERING. THE BODY OF THE TEXT SHALL BE IN BLACK LETTERING W/ 0.2 INCH HIGH LETTERS. THE REF LINE SHALL NE IN 1/8 INCH LETTERS.

THE PLACEMENT OF TEXT SHALL BE DONE IN A MANNER THAT WILL PERMIT EASY READING FROM A DISTANCE OF APPROXIMATELY 6 FEET IN FRONT OF THE SIGN.

ALL PAINT WILL BE BAKER W/ ENAMEL W/ UV PROTECTIVE COATING OVER THE FACE OF THE

INFORMATION ON THE OUTSIDE FACE OF THIS BUILDING ON THIS STRUCTURE THIS IS ATAT MOBILITY SITE CYL02102

INFORMATION SIGN 1-2

INFORMATION SIGN 1-4

at&t

INFORMATION SIGN 1-

SION 2 MUST BE A NON METALLIC LABEL W/ AN ADHESIVE BACKING, THE LABEL SHALL BE MADE USING VAIYL OR SMILAR WEATHERPROOF MATERIAL, THE LABEL SHALL BE APPROXIMATELY 5X7 INCHES W/ A WHITE BACKGROUND AND BLACK LETTERING. THE GREEN BAND SHALL BE 1,375 INCH IN HEIGHT & THE LETTERING SHALL BE BLACK W/ 0.75 INCH HIGH LETTERS. THE TEXT LETTERING SHALL BE BLACK W/ 1/8 INCH HIGH LETTERS. UV PROTECTION SHALL BE PLACED OVER THE FRONT OF THE LABEL.

*SIGN 1-3: BACK OF ANTENNAS, SEE DETAIL 1C & 3, THIS SHEET

*SIGN 3 IS A 1 INCH X 2 INCH PANEL THAT CAN BE APPLIED TO THE BACK OR SIDE OF AN ANTENNA TO IDENTIFY IT AS AN AT&T ANTENNA.

*SIGN 1-4: SIDE OF ANTENNAS, SEE DETAIL 1D & 3, THIS SHEET

SIGN 4 IS MADE FROM TRANSPARENT MATERIAL 1-1/2 INCHES WIDE & 24 INCHES LONG. THE LETTERING IS TO BE BLACK W/ 1/2 INCH LETTERING IN A VERTICAL COLUMN. THE SPACING BETWEEN WORDS MUST BE SUCH THAT IT IS EASILY READ & FILLS THE LENGTH OF THE SIGN

SIGNAGE AND STRIPING INFORMATION

- THE FOLLOWING INFORMATION IS A GUIDELINE W/ RESPECT TO PREVAILING STANDARDS LIMITING HUMAN EXPOSURE TO RADIO FREQUENCY ENERGY AND SHOULD BE USED AS SUCH. IF THE SITE'S EMF REPORT OR ANY LOCAL, STATE OR FEDERAL GUIDELINES OR REGULATIONS SHOULD BE IN CONFLICT W/ ANY PART OF THESE NOTES OR PLANS, THE MORE RESTRICTIVE GUIDELINE OR RECULATION SHALL BE FOLLOWED AND OVERRIDE THE LESSER.
- THE PUBLIC LIMIT OF RF EXPOSURE ALLOWED BY AT&T IS IMMCM*2 AND THE OCCUPATIONAL LIMIT OF RF EXPOSURE ALLOWED BY AT&T IS SAWKM*2
- IF THE BOTTOM OF THE ANTENNA IS MOUNTED (8) EIGHT FEET ABOVE THE GROUND OR WORKING PUBLIC LIMIT OF RE EXPOSURE LIMIT THEN NO STRIPING OR BARRICADES SHOULD BE NEEDED.
- IF THE PUBLIC LIMIT OF RF EXPOSURE ON THE SITE IS EXCEEDED AND THE AREA IS PUBLICLY IT THE PUBLIC UNIT OF THE ENTYSIANS ON THE STREETS EXCELLED AND THE AREA IS PUBLIC THE AREA IS PUBLIC. ACCESSIBLE (E.G. ROOF ACCESS DODGE THAT CANNOT BE LOCKED, OR FIRE EGRESS) THEN BOTH BARRICADES AND STRIPPING SHALL BE DETERMINED BY THE EMF REPORT FOR THE SITE DONE BEFORE OR SHORTLY AFTER COMPLETION OF SITE CONSTRUCTION. USE THE PLANS AS A GUIDELINE FOR PLACEMENT OF SUCH BARRICADES AND STRIPPING.
- IF THE PUBLIC LIMIT OF RF EXPOSURE ON THE SITE IS EXCEEDED AND THE AREA IS PUBLICLY ACCESSIBLE (E.G. ROOF ACCESS DOOR THAT CANNOT BE LOCKED, OR FIRE EGRESS) THEN BOTH BARRICADES AND STRIPING SHALL BE PLACED AROUND THE ANTENNAS. THE EXACT EXTENT OF THE BARRICADES AND STRIPING SHALL BE PLACED AROUND THE ANTENNAS. THE EXACT EXTENT OF THE BARRICADES & STRIPING SHALL BE DETERMINED BY THE EMP REPORT FOR THE SITE DONE BEFORE OR SHORTLY AFTER COMPLETION OF SITE CONSTRUCTION. USE THE PLANS AS A GUIDELINE FOR PLACEMENT OF SUCH BARRICADES AND STRIPING.
- ALL TRANSMIT ANTENNAS REQUIRE A THREE LANGUAGE WARNING SION WRITTEN IN ENGLISH, SPANISH, AND CHINESE. THIS SION SHALL BE PROVIDED TO THE CONTRACTOR Y THE ATAT CONSTRUCTION PROJECT MANAGER AT THE TIME OF CONSTRUCTION. THE LARGER SIGN SHALL BE PLACED IN PLAIN SIGHT AT ALL ROOF ACCESS LOCATIONS AND ON ALL BARRICADES. THE SMALLER SIGN SHALL BE PLACED ON THE ANTENNA ENCLOSURES IN A MANNER THAT IS EASILY SEEN BY SAY STALL BE PLACED UN THE AVERNA ENGLOSMES IN A MANNER THAT IS EXSET SEEN BY ANY PERSON ON THE ROOF, MARNING SIGNS STALL COMPLY W/ ANSI C95.2 COLOR, SYMBOL, AND CONTENT CONVENTIONS. ALL SIGNS SHALL HAVE AT&T'S NAME AND THE COMPANY CONTACT INFORMATION (E.G. TILEPHONE NUMBER) TO ARRANGE FOR ACCESS TO THE RESTRICTED AREAS. THIS TILEPHONE NUMBER SHALL BE PROVIDED TO THE CONTRACTOR BY THE AT&T CONSTRUCTION PROJECT MANAGER AT THE TIME OF CONSTRUCTION.
- PHOTOS OF ALL STRIPING, BARRICADES & SIGNAGE SHALL BE PART OF THE CONTRACTORS CLOSE OUT PACKAGE & SHALL BE TURNED INTO THE ATAIT CONSTRUCTION PACKAGE & SHALL BE TURNED INTO THE ATAIT CONSTRUCTION PACKAGE WAS ATAIL BE TURNED INTO THE ATAIT CONSTRUCTION PROJECT MANAGER AT THE END OF CONSTRUCTION. STREPINS SHALL BE DONE WE FADE RESISTANT YELLOW SAFETY PAINT IN A CROSS-ATACH PATTERN AS BETALLED BY THE CONSTRUCTION DRAWMOS. ALL BARRICADES SHALL BE MADE OF AN RF FRENDLY MATERIAL SO AS NOT TO BLOCK OR INTERFERE W/ THE OPERATION OF THE ANTENNAS. BARRICADES SHALL BE PAINTED MY FADE RESTRAINT YELLOW SAFETY PAINT. THE CONTRACTOR SHALL PROVIDE ALL REFRIENDLY BARRICADES NEEDED, & SHALL PROVIDE THE AT&T CONSTRUCTION PROJECT MANAGER W,
- B. SHOP DRAWING OF EACH BARRICADE, UPON CONSTRUCTION COMPLETION.

FENCED COMPOUND SIGNAGE

INFORMATION SIGNAGE

GENERAL NOTES

AUTHORIZED PERSONNEL

DOOR/EQUIPMENT SIGN

Property of AT&T

Authorized Personnel Only

In case of emergency, or prior to performing maintenance on this site, call and reference cell site number

INFORMATION Federal Communications Communication

Tower Registration Number

234567

Authorized

No Trespassina Violators will be Prosecuted

in case of emergency, or prior to performing maintenance on this site, call and reference cell site number

- CONTRACTOR SHALL INSTALL ALL INFORMATIO SIGNAGE IN ACCORDANCE W/ AT&T WIRELESS
 DOCUMENT #03-0074, RF EXPOSURE POLICY AND RF SAFETY COMPLIANCE PROGRAM, LATEST EDITION
- CONTRACTOR SHALL CONTACT AT&T R-RFSC FOR INFORMATION ON MPE LEVELS AND INSTRUCTIONS ON LEVEL AND LOCATION OF SIGNAGE

WARNING



Beyond This Point you are entering a controlled area where RF Emissions exceed the FCC Controlled Exposure limits Fallure to obey all posted signs and site guidelines could result in serious injury

Ref: FCC 47CFR 1.1307(b)

CAUTION



Beyond This Point you are entering a controlled area where RF Emissions may exceed the FCC Controlled Exposure limits

Obey all posted signs and atte guidelines for working in an RF environment

Ref: FCC 47CFR 1.1307/b

NOTICE



Beyond This Point you are entering an area where RF Emissions may exceed the FCC General Population Exposure Limits

Follow all posted signs and site guidelines for working in an RF e

Ref: FCC 47CFR 1.1307(b)

nt&t

PROPRIETARY INFORMATION

THE INFORMATION CONTAINED IN THIS

SET OF DRAWINGS IS PROPRIETARY
BY NATURE. ANY USE OR
DISCLOSURE DITHER THAN THAT WHICH
RELATES TO PEEK SITE-COM IS
STRICTLY PROHIBITED

5001 EXECUTIVE PKWY SAN RAMON, CA 94583

CAMP PADREE

5001 OAK MEADOWS CT. IONE , CA 95640

Peek Site-Com 12852 Earhart Ave. Suite 101 Auburn, California 95602 Phone (530) 885-6160

E-Mail info@peeksitecom.com

SITE SIGNAGE

5-22-17 90% ZONING DOC'S

4 9-19-17 REV 100% ZONING DOC'S

2 6-6-17 90% ZONING DOC'S

3 8-24-17 100% ZONING DOC'S

COORDINATING ENGINEER:=

SEAL: =

CVL02102

SHEET TITLE: :

DESCRIPTION:

RY-

ALP

ALP

TAP

RB

CLIENT: =

PROJECT INFORMATION: =

REV: = DATE: ====

= REVISION:=

= DRAWN BY:

ALP

FCC ASR SIGNAGE

Property of AT&T Personnel Only

CAUTION AND WARNING SIGN

NOTICE SIGN

SHELTER/CABINET DOORS SIGNAGE GATE SIGNAGE

26

DATE OF SURVEY: 04-27-17

SURVEYED BY OR UNDER DIRECTION OF: KENNETH D. GEIL, R.C.E. 14803

LOCATED IN THE COUNTY OF AMADOR, STATE OF CALIFORNIA

BEARINGS SHOWN ARE BASED UPON MONUMENTS FOUND AND RECORD INFORMATION. THIS IS NOT A BOUNDARY SURVEY.

ELEVATIONS SHOWN ON THIS PLAN ARE BASED UPON U.S.G.S. N.A.V.D. 88 DATUM. ABOVE MEAN SEA LEVEL.

N.G.V.D. 1929 CORRECTION: SUBTRACT 2.39' FROM ELEVATIONS SHOWN.

CONTOUR INTERVAL: 1 FT.

CONTRACTOR IS RESPONSIBLE TO VERIFY LEASE AREA PRIOR TO CONSTRUCTION.

ASSESSOR'S PARCEL NUMBER: 012-080-037

JOSEPH JOHN SR. & CONNIE LEE JESS TRUST 5001 OAK MEADOWS CT. OWNER(S):

IONE, CA 95640

A.T.& T. Mobility

Project No./Name: CVL02102 / CAMP PADREE

Project Site Location:

Amador County


Equipment/Procedure Used to Obtain Coordinates: Trimble Geo XT post processed with Pathfinder Office software.

Type of Antenna Mount: Proposed Monopine Tower

Coordinates (Center Lease Area)

N 38"16'51.19" (NAD83) N 38"16'51.49" (NAD27) W 120'52'34.82" (NAD83) W 120'52'31.04" (NAD27)

ELEVATION of Ground at Structure (NAVD88) 684' AMSL

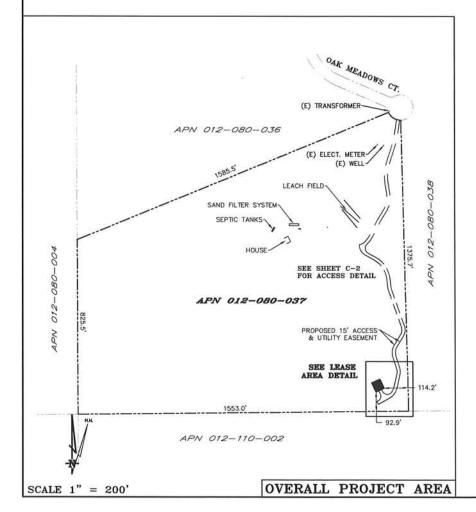


Lease Area Description

All that certain lease area being a portion of "Adjusted Parcel 6" as is shown on that certain plat, filed for record in Book 51 of Record of Surveys, Page 16, Amador County Records, located in the County of Amador, State of California, and being a portion of the Southeast 1/4 of Section 16, Township 05 N., Range 10 E., M.D.B.& M., and being more particularly described as follows:


Commencing at the Southeast corner of the aforementioned Adjusted Parcel 6; thence South 89°23'47" West, 152.19 feet and North 0°36'13" West, 92.86 feet to the True Point of Beginning; thence from soid point of beginning North 65"16'26" East, 40.00 feet; thence North 24'43'34" West, 45.00 feet; thence South 65"16'26" West, 40.00 feet; thence South 24'43'34" East, 45.00 feet to the point of


Together with a non-exclusive easement for access and utility purposes, purposes filteen feet in width, the centerline of which is more particularly described as follows: Beginning at a point which bears South 6516'26' West, 20.00 feet from the Southeast corner of the above described lease area; thence from said point of beginning South 29'23'52" East, 47-94 feet; thence North 60'36'08" Eost, 20.67 feet; thence along a tangent curve to the Northeast, having a radius of 55.00 feet and a central angle of 47'41'41'; thence along asid curve a distance of 54.11 feet,; thence North 12'54'27" East, 55.40 feet; thence along a tangent curve to the North, howing a radius of 50.00 feet and a central angle of 30'56'58"; thence along said curve a distance of 54.11 feet,; thence along at angent curve to the North, howing a radius of 50.00 feet and a central angle of 30'54'54'; thence along said curve a distance of 55.41 feet,; thence North 30'48'15" East, 58.72 feet; thence along a tangent curve to the North soft, howing a radius of 50.00 feet and a central angle of 50'12'07"; thence along said curve a distance of 55.40 feet; thence along said curve a distance of 43.81 feet,; thence North 19'23'52" West, 178.14 feet; thence along a tangent curve to the North, having a radius of 50.00 feet and a central angle of 50'12'07"; thence along sold curve a distance of 16.18 feet; thence North 7'02'00" West, 45.28 feet; thence along a tangent curve to the North, having a radius of 15.00 feet and a central angle of 50'12'00" West, 45.28 feet; thence North 60'27'39" West, 49.49 feet; thence along a tangent curve to the Northwest, having a radius of 50.00 feet and a central angle of 50'12'00'; thence along said curve a distance of 43.92 feet to the existing driveway, thence clong said curve a distance of 43.92 feet to the existing driveway, thence along said curve a distance of 43.92 feet to the existing driveway, thence along said curve a distance of 43.92 feet to the existing driveway in a Northeasterly direction 660 feet more or less

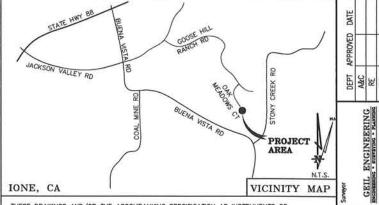

THESE DRAWINGS AND/OR THE ACCOMPANYING SPECIFICATION AS INSTRUMENTS OF SERVICE, ARE THE EXCLUSIVE PROPERTY OF GEIL ENGINEERING AND THEIR USE AND PUBLICATION SHALL BE RESTRICTED TO THE ORIGINAL SITE AND CARRIER FOR WHICH THEY ARE PREPARED. REUSE, REPRODUCTION OR PUBLICATION BY ANY METHOD, IN WHOLE OR IN PART, IS PROHIBITED EXCEPT BY WRITTEN PERMISSION FROM GEIL ENGINEERING. TITLE TO THESE PLANS AND/OR SPECIFICATIONS SHALL REMAIN WITH GEIL ENGINEERING WITHOUT PREJUDICE AND VISUAL CONTACT WITH THEM SHALL CONSTITUTE PRIMA FACIE EVIDENCE OF ACCEPTANCE OF THESE RESTRICTIONS.

BOUNDARY SHOWN IS BASED ON MONUMENTATION FOUND AND RECORD INFORMATION. THIS IS NOT A BOUNDARY SURVEY. THIS IS A SPECIALIZED TOPOGRAPHIC MAP WITH PROPERTY LINES AND EASEMENTS BEING A GRAPHIC DEPICTION BASED ON INFORMATION GATHERED FROM VARIOUS SOURCES OF RECORD AND AVAILABLE MONUMENTATION FOUND DURING THE FIELD SURVEY. NO EASEMENTS WERE RESEARCHED OR PLOTTED. PROPERTY LINES AND LINES OF TITLE WERE NOT INVESTIGATED NOR SURVEYED. NO PROPERTY MONUMENTS WERE SET.

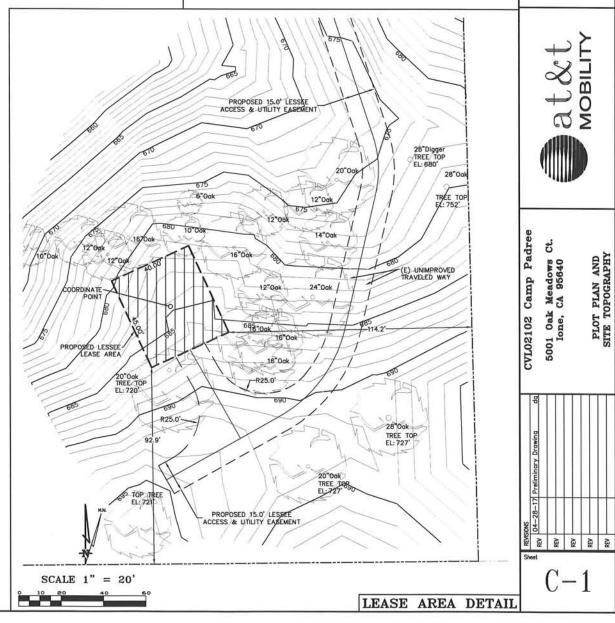

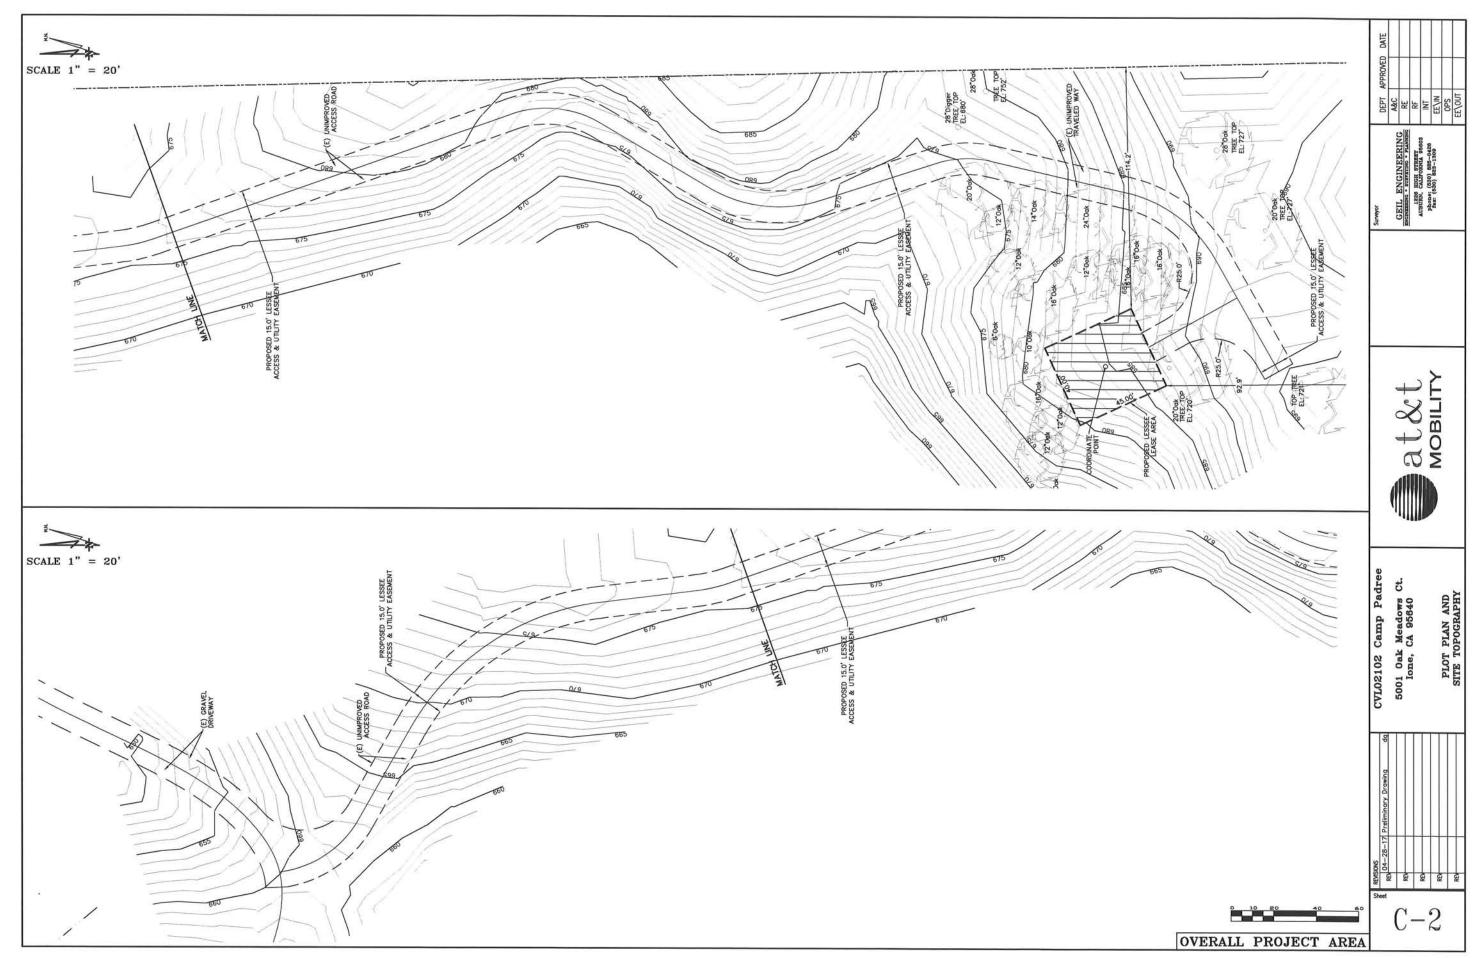

GENERAL NOTES

- . THE CONTRACTOR SHALL HAVE A RESPONSIBLE PARTY, WHO SHALL HAVE THE AUTHORITY TO REPRESENT AND ACT FOR THE CONTRACTOR, ON THE JOB SITE DURING ALL WORKING
- ALL WORK SHALL BE ACCOMPLISHED TO THE SATISFACTION OF THE WASHOE COUNTY AUTHORIZED REPRESENTATIVE.

DEFINITIONS:

(ESC) - EROSION AND SEDIMENT CONTROL
(NPDES) - NATIONAL POLLUTANT DISCHARGE ELIMINATION SYSTEM

(CWA) — CLEAN WATER ACT
(SWPPP) — STORM WATER POLLUTION PREVENTION PLAN
(BMP'S) — BEST MANAGEMENT PRACTICES

THE CONTRACTOR SHALL:

MAKE HIM/HERSELF AWARE OF THE REQUIREMENTS OF SAID GENERAL PERMIT AND THE PROVISIONS OF THE GRADING & EROSION CONTROL PLANS.

IMPLEMENT THE ESC FEATURES AND BEST MANAGEMENT PRACTICES (BMP'S) CONTAINED IN THE IMPROVEMENT PLANS, AND OTHERWISE DILIGENTLY PURSUE COMPLIANCE WITH THE LOCAL REQUIREMENTS.

ASSIST THE OWNER, ENGINEER, AND PUBLIC WORKS DEPARTMENT STAFF IN THE ASSESSMENT OF THE FUNCTIONALITY OF AND MODIFICATIONS TO THE FEATURES AND PRACTICES IMPLEMENTED AND PROPOSED.

MEET WITH THE OWNER AND THE PUBLIC WORKS DEPARTMENT STAFF TO DETERMINE AND DISCUSS THE STATUS OF THE PROJECT, CONSTRUCTION SCHEDULE, AND ANY MODIFICATIONS AND/OR ADDITIONS TO THE ESC FEATURES IN ORDER TO DILIGENTLY PURSUE COMPLIANCE.

DOCUMENT ANY MAINTENANCE, REPLACEMENT, INSPECTION, MODIFICATIONS OR ADDITIONS TO THE PROJECT ESS FEATURES, AND NOTIFY THE ENGINEER. OWNER AND PUBLIC WORKS DEPARTMENT STAFF OF ANY SUBSTANTIAL MODIFICATIONS OR ADDITIONS TO THE ESS PRACTICES AND FEATURES. ALL DISTURBED AREAS SHALL BE PROTECTED WITH APPROVED MATERIALS WITHIN 15 DAYS OF COMPLETION OF THE FINISHED GRADES.

MAINTAIN AN INVENTORY OF ESC MATERIALS (STRAW BALES, 1.5" - 3" CLEAN CRUSHED ROCK. FIBER ROLLS, SILT FENCE, ROCK BAGS, ETC.) ON SITE FOR EMERGENCY USE AS DIRECTED BY THE ENGINEER, OWNER, OR THE PUBLIC WORKS DEPARTMENT STAFF.

OTHER RESPONSIBILITIES OF APPLICANT:

- A. PROTECTION OF UTILITIES. THE APPLICANT SHALL BE RESPONSIBLE FOR THE PREVENTION OF DAMAGE TO ANY PUBLIC UTILITIES OR SERVICES.
- B. PROTECTION OF ADJACENT PROPERTY. THE APPLICANT SHALL BE RESPONSIBLE
- C. FOR THE PREVENTION OF DAMAGE TO ADJACENT PROPERTY. NO PERSON(S) SHALL EXCAVATE ON LAND THAT IS SO CLOSE TO THE PROPERTY LINE AS TO ENDANGER ANY ADJOINING PUBLIC STREET, SIDEWALK, ALLEY, STRUCTURE OR OTHER PUBLIC OR PRIVATE PROPERTY OR EASEMENT WITHOUT SUPPORTING AND PROTECTING SUCH PROPERTY FROM ANY DAMAGE WHICH MIGHT OTHERWISE RESULT.
- D. ADVANCE NOTICE. THE APPLICANT SHALL NOTIFY THE COUNTY AT LEAST FORTY-EIGHT HOURS PRIOR TO THE START OF WORK.
- EROSION AND SEDIMENT CONTROL, IT SHALL BE THE SOLE RESPONSIBILITY OF THE APPLICANT TO PREVENT DISCHARGE OF SEDIMENT FROM THE SITE, IN QUANTITIES GREATER THAN BEFORE THE GRADING OCCURRED, TO ANY WATERCOURSE, DRAINAGE SYSTEM, OR ADJACENT
- COMPLIANCE WITH STORMWATER RUNOFF POLLUTION CONTROL CODE. AT ALL TIMES DURING THE PRECONSTRUCTION AND CONSTRUCTION OF ANY PROJECT FOR WHICH GRADING APPROVAL IS ISSUED UNTIL ALL FINAL IMPROVEMENTS AND PERMANENT STRUCTURES ARE COMPLETE, THE APPLICANT SHALL FULLY COMPLY WITH ALL APPLICABLE REQUIREMENTS OF THE STORMWATER RUNOFF POLLUTION CONTROL CODE.

BEST MANAGEMENT PRACTICE	LOCATION	IMPLEMENTATION SCHEDULE	MAINTENANCE SCHEDULE
A PRESERVING EXISTING VEGETATION	AROUND PERIMETER OF PROJECT SITE	CONTINUOUS, UNTIL CONSTRUCTION IS COMPLETED	EDUCATE EMPLOYEES AND SUBCONTRACTORS RECARDING IMPORTANCE AT MAINTAINING EDISTING VEGETATION TO PREVENT EROSION AND FILER AND SEDMENT IN RUNDF FROM DISTURBED AREAS ON THE CONSTRUCTION STEL INSPECT SITE PRIMETER MOSTHLY TO VERIFY THE OUTSIDE VEGETATION IS NOT DISTURBED.
B. PROTECT GRADED AREAS AND SLOPES FROM WASHOUT & EROSION	THROUGHOUT PROJECT SITE	DURING WET SEASON	INSPECT GRADED AREAS AND SLOPES ON AT LEAST A MONTHLY BASIS TO CHECK FOR EROSION. REGRADE TRIBUTARY AREAS OR INSTALL FILTER BARRIER OR SAND BAG DOKES AS NECESSARY TO PREVENT EROSION.
C. GRAVEL FILTER	ALONG FLOW LINES OF UNPAVED ROADWAYS WITHIN SITE	IN PLACE DURING WET SEASON UNTIL ROADWAYS ARE PAVED	INSPECT DAILY AND AFTER EACH STORM, REMOVE ONSITE SEDIMENT DEPOSITED BEHIND BERM OR BARRIER TO MAINTAIN EFFECTIVENESS.
D. INLET FILTER BAG	INLETS TO THE STORM DRAINAGE SYSTEM	CONTINUOUS UNTIL LANDSCAPING IS IN PLACE	INSPECT WEEKLY AND AFTER EACH STORM, REMOVE SEDIMENT AND DEBRIS BEFORE ACCUMULATIONS HAVE REACHED ONE THIRD THE DEPTH OF THE BAG, REPAIR OR REPLACE INLET FILTER BAG AS SOON AS DAMAGE OCCURS.
E. FIBER ROLL	SEE PLAN SHEET C-4	CONTINUOUS	INSPECT WEEKLY AND AFTER EACH STORM, REMOVE SEDIMENT DEPOSITED BEHIND FIBER ROLL WHENEVER NECESSARY TO MAINTAIN EFFECTIVENESS.
F. HYDROSEEDING	3:1 SLOPES	IN PLACE DURING BY SEPT. 15	INSPECT SLOPES ON AT LEAST A MONTHLY BASIS TO CHECK FOR EROSION. IF EROSION IS NOTED, SPREAD STRAW MULCH OVER AFFECTED AREAS.
G. STABILIZED CONSTRUCTION ENTRANCE	ENTRANCES TO SITE FROM PUBLIC ROADWAYS	CONTINUOUS, UNTIL ENTRANCES AND ONSITE ROADWAYS ARE PAVED	INSPECT ON A MONTHLY BASIS AND AFTER EACH RAINFALL. ADD AGGREGATE BASE MATERIAL WHENEVER NECESSARY TO PREVENT SEDIMENT FROM BEING TRACKED INTO PUBLIC STREET.
H. WIND EROSION CONTROL PRACTICES	WHEREVER NECESSARY THROUGHOUT PROJECT SITE	CONTINUOUS UNTIL GRADING IS COMPLETED AND SOILS HAVE STABILIZED	INSPECT SITE DURING WINDY CONDITIONS TO IDENTIFY AREAS WHERE WIND EROSION IS OCCURRING AND ABATE EROSION AS NECESSARY
I, GOOD HOUSEKEEPING MEASURES	THROUGHOUT PROJECT SITE	CONTINUOUS UNTIL CONSTRUCTION IS COMPLETED	INSPECT SITE ON AT LEAST A MONTHLY BASIS TO VERFY THAT GOOD HOUSEKEEPING PRACTICES ARE BEING IMPLEMENTED.
J. PROPER CONSTRUCTION MATERIAL STORAGE	DESIGNATED AREA	CONTINUOUS UNTIL CONSTRUCTION IS COMPLETED	INSPECT SITE ON AT LEAST A WEEKLY BASIS TO VERIFY THAT CONSTRUCTION MATERIALS ARE STORED IN A MANNER, WHICH COULD NOT CAUSE STORM WATER POLLUTION.
K. PROPER CONSTRUCTION WASTE STORAGE AND DISPOSAL INCLUDING	DESIGNATED COLLECTION AREA AND CONTAINERS	CONTINUOUS UNTIL CONSTRUCTION IS COMPLETED	INSPECT SITE ON AT LEAST A WEEKLY BASIS TO ASSURE WASTE IS STORED PROPERLY AND DISPOSED OF AT LEGAL DISPOSAL SITE, DAILY.
CONCRETE SPILL CLEANUP INCLUDING PAINT & PAINTING SUPPLIES	MATERIAL HANDLING AREA	IMMEDIATELY AT TIME OF SPILL	INSPECT MATERIAL HANDING AREAS ON AT LEAST A MONTHLY BASIS TO VERIFY PROPER SPILL CLEANUP.
2) VEHICLE FUELING MAINTENANCE & CLEANING	DESIGNATED AREA WITH SECONDARY CONTAINMENT	CONTINUOUS	KEEP AMPLE SUPPLIES OF SPILL CLEANUP MATERIALS ON SITE & INSPECT ON REGULAR SCHEDULE.
L. STREET AND STORM DRAINAGE FACILITY MINTENANCE DEFINITIONS	STREETS AND STORM DRAINAGE FACILITIES	CONTINUOUS UNTIL CONSTRUCTION IS COMPLETED	MAINTAIN STORM DRAINAGE FACILITIES AND PAVED STREETS CLEAR OF SEDIMENT AND DEBRIS.

- . WET SEASON: ENTIRE PERIOD BETWEEN OCTOBER 1 THROUGH APRIL 30. CONTRACTOR SHALL ALSO IMPLEMENT WET SEASON MEASURES IF WET WEATHER IS EXPECTED DURING THE DRY SEASON.

 PHASES OF GRADING
- PHASES OF GRADING
 HITML (STAGE 1): WHEN CLEARING AND GRUBBING ACTIVITIES OCCUR.
 ROUGH (STAGE 2): WHEN CUT AND FILL ACTIVITIES OCCUR AND THE SITE IMPROVEMENTS ARE CONSTRUCTED, INCLUDING
 LINDERGROUND PIPING, STREETS, SIDEWALKS, AND OTHER IMPROVEMENTS.
 FINAL (STAGE 3): WHEN FINAL ELEVATIONS ARE SET, AND SITE IMPROVEMENTS ARE COMPLETED AND READY FOR COUNTY

REQUIRED BMPS

ALL EROSION AND SEDIMENT CONTROL MEASURES SHALL BE CONSTRUCTED AND MAINTAINED IN ACCORDANCE WITH THE COUNTY IMPROVEMENT STANDARDS, CURRENT EDITION, AND THE COUNTY FROSION AND SEDIMENT CONTROL GUIDELINES.

EROSION CONTROL NOTES

- 2. EROSION CONTROL BEST MANAGEMENT PRACTICES (BMPs) SHALL BE INSTALLED AND MAINTAINED DURING THE WET SEASON (OCTOBER THROUGH APRIL 30). SEDIMENT CONTROL BMPs SHALL BE INSTALLED AND MAINTAINED ALL YEAR.
- 3. ALL DRAINAGE INLETS IMMEDIATELY DOWNSTREAM OF THE WORK AREAS AND WITHIN THE WORK AREAS SHALL BE PROTECTED WITH SEDIMENT CONTROL AND INLET FILTER BAGS, YEAR ROUND. INLET FILTER BAGS SHALL BE REMOVED FROM THE DRAINAGE INLETS UPON ACCEPTANCE OF THE PUBLIC IMPROVEMENTS BY THE COUNTY.
- 4. ALL AREAS DISTURBED DURING CONSTRUCTION, BY GRADING, TRENCHING, OR OTHER ACTIVITIES, SHALL BE PROTECTED FROM EROSION DURING THE WET SEASON (OCTOBER 1 THROUGH APRIL 30). HYDROSEED, IF UTILIZED, MUST BE PLACED BY SEPTEMBER 15. HYDROSEED PLACED DURING THE WET SEASON SHALL USE A SECONDARY EROSION PROTECTION METHOD.
- 5. SENSITIVE AREAS AND AREAS WHERE EXISTING VEGETATION IS BEING PRESERVED SHALL BE PROTECTED WITH CONSTRUCTION FENCING, SEDIMENT CONTROL BMPs SHALL BE INSTALLED WHERE ACTIVE CONSTRUCTION AREAS DRAIN INTO SENSITIVE OR PRESERVED VEGETATION
- 6. SEDIMENT CONTROL BMPs SHALL BE PLACED ALONG THE PROJECT PERIMETER WHERE DRAINAGE LEAVES THE PROJECT. SEDIMENT CONTROL BMPs SHALL BE MAINTAINED YEAR ROUND UNTIL THE CONSTRUCTION IS COMPLETE OR THE DRAINAGE PATTERN HAS BEEN CHANGED AND NO LONGER LEAVES THE SITE.
- THE FOLLOWING AREAS ARE TO RECEIVE HYDROSEEDING OR OTHER EROSION CONTROL: ALL SLOPES GREATER THAN 10:1.
- 8. FOR DEWATERING OPERATIONS, SEDIMENT- LADEN STORM WATER SHALL BE FITHER PLIMPED (NOTE 10) OR ROUTED (TEMPORARY DIVERSION SWALE) TO SEDIMENT TRAPE(S) TO ALLOW SEDIMENT TO SETTLE OUT BEFORE DISCHARGE OFF-SITE. ONCE SEDIMENT HAS SETTLED OUT, WATER WILL BE DISCHARGED THROUGH SWALE INSED WITH IMPERVIOUS PLASTIC LINES.
- 9. USE OF FIBER ROLLS SHALL BE AUGMENTED DURING WET SEASON WITH DEWATERING BMP's I THE EVENT THAT FIBER ROLLS DO NOT EFFECTIVELY RETAIN STORM WATER ON SITE. DEWATERING MAY INCLUDE PUMPS OR BERMS TO ROUTE WATER TO THE SEDIMENT TRAP, IF PUMPS ARE USED, THEN FILTER BAGS SHALL BE USED AT DISCHARGE HOSE ENDS. DEWATERING MATERIAL SHALL NOT BE DISCHARGED DIRECTLY TO THE STORM DRAIN SYSTEM.

THE FOLLOWING BMPS SHALL BE REQUIRED ON ALL PROJECTS:

- A. ACCESS POINTS TO THE CONSTRUCTION SITE SHALL HAVE A STABILIZED CONSTRUCTION ACCESS.
- B. THE PRESERVATION OF EXISTING VEGETATION SHALL BE DONE IN ACCORDANCE WITH PRESERVATION OF EXISTING VEGETATION, AND SILT FENCE
- C. PERIMETER PROTECTION ALONG PROPERTY LINES SHALL HAVE PRESERVATION OF EXISTING
- D. SLOPES GREATER THAN 3 PERCENT SHALL BE TEMPORARILY SEEDED AND SLOPES GREATER 3:1 (H:V) SHALL HAVE HYDROSEEDING AND/OR GEOTEXTILES, PLASTIC COVERS, AND/OR EROSION CONTROL BLANKETS INSTALLED.
- E. THE TOE OF ALL SLOPES SHALL HAVE SILT FENCE AND/OR FIBER ROLL
- DISTURBED SOIL AREAS BEHIND THE CURB OR BACK OF WALK (OR CURB) SHALL HAVE STRAW MULCH, SOIL BINDERS OR GEOTEXTILES, PLASTIC COVERS, AND EROSION CONTROL BLANKETS/MATS IN CONJUNCTION WITH HYDROSEDING, SUFFACE TREATMENTS SHALL EXTEND TO THE GREATER OF 6 METERS (20 FEET) OR TO THE TOP OF SLOPE.
- G. ROADWAY SUBGRADES SHALL HAVE FIBER ROLL, SILT FENCE, OR SEDIMENT TRAP.
- H. DEAD END STREETS, TO BE EXTENDED IN THE FUTURE, SHALL HAVE PRESERVATION OF EXISTING VEGETATION, HYDROSEEDING, SEDIMENT TRAP OR OTHER APPLICABLE BMP TO MINIMIZE THE TRANSPORT OF SEDIMENT ONTO OR FROM THE IMPROVED SURFACE.
- PROJECTS THAT INCLUDE DETENTION BASINS SHALL HAVE A SEDIMENT BASIN.
- J. PLACE DRAINAGE INLET SEDIMENT BMPS AT ALL STORM DRAIN INLETS. BMPS SHALL INCLUDE INLET SEDIMENT CONTROL BARRIER, INLET FILTER BAG AND CONCRETE STAMPS OR EXPOXIED PLAQUARDS.
- K. EACH CONSTRUCTION SITE SHALL PROVIDE DESIGNATED, PAINT AND WASTE DISPOSAL LOCATIONS AS
- L. A BMP INSTALLATION SCHEDULE SHALL BE INCLUDED ON THE IMPROVEMENT PLANS. THE SCHEDULE SHALL INCLUDE THE BMPS FOR BOTH THE WET SEASON AND THE DRY SEASON.



PORTABLE CONCRETE WASHOUT CONTAINER

INSPECTION & MAINTENANCE OF FIBER ROLLS:

REPAIR OR REPLACE SPLIT, TORN, UNRAVELING OR SLUMPING FIBER

100 MM (4 IN.) MAX FIBER ROLL 200 MM MIN. (8 IN.) SLOPE VARIES INSTALL A FIRER ROLL NEAR SLOPE WHERE TRANSITIONS INTO A STEEPER SLOPE 300 MM MIN. (3/4 IN. x 3/4 IN.) WOOD STAKES MAX. (12 IN.) 1.2 M (4 FT.) SPACING

TYPICAL FIBER ROLL INSTALLATION

ROLLS.

2. INSPECT FIBER ROLLS WHEN RAIN IS FORECAST, FOLLOWING RAIN EVENTS, AL LEAST DAILEY DURING PROLONGED RAINFALL, AND AT TWO-WEEK INTERVALS DURING THE NON-RAINF SEASON.

3. SEDMENT SHOULD BE REMOVED WHEN SEDIMENT ACCUMULATION REACHES ONE-HALF THE DESIGNATION SEDMENT STORAGE "DEPTH, USUALLY ONE-HALF THE DISTANCE BETWEEN THE TOP OF THE FIBER ROLL AND THE ADJACENT RORUND SUFFRACE, SEDIMENT REMOVED DURING MAINTENANCE MAY BE INCORPORATED INTO THE EARTHWORK ON THE SITE OR DISPOSED AT AN APPROPRIANCE LOCATION. NOTES:

NOTES:

1. FILTER BARRIER SHALL BE CONSTRUCTED LONG ENOUGH TO EXTEND ACROSS THE EXPECTED FLOW PATH AND AS APPROVED BY THE LANDSCAPE INSPECTIOR.

2. FILTER ROLL (8°TO 12° DIAMETER) SHALL BE PLACED INTO THE KEY TRENCH AND STAKES ON BOTH SIDES OF THE ROLL WITHIN IN FEET OF EACH END AND THEN EVERY 3' TO 44 WITH 1' X 2' X' STAKES.

2. FILTER ROLL AND STAKES ON BOTH SIDES OF THE ROLL WITHIN IN FEET OF EACH END AND THEN EVERY 3' TO 44 WITH 1' X 2' X' STAKES.

3. CLEAR SUBGRADE SO THAT REMOVAL OF ALL LOCAL DEVIATIONS AND TO REMOVE LANGE STONES OR DEBRIS THAT WILL INHIBIT INTIMATE CONTACT OF THE FIBER ROLL WITHIN THE SUBGRADE AND ACKNOST THE REMOVAL AND ACKNOST THE ROLL SHALL EXTEND THE AND ACKNOST THE BOTTOM OF THE FIBER STALL AND ROLL SHALL EXTEND TO AND ACROSS THE BOTTOM OF THE FIRENCH. THE TRENCH SHALL BE INSTALLED ALONG THE SIDE OF WALKS AND AROUND THE CANCH BUSING. THE BOTTOM OF THE FIRENCH THE TRENCH SHALL BE INSTALLED ALONG THE SIDE OF WALKS AND AROUND THE AND ACROSS THE BOTTOM OF THE FIRENCH THE TRENCH SHALL STEAD TO AND ACROSS THE BOTTOM OF THE FIRENCH THE TRENCH SHALL SHALL EXTEND TO AND ACROSS THE BOTTOM OF THE FIRENCH SHALL SHALL EXTEND THE SEASON, MONTHLY DURING THE DIFF SEASON AND IMMORTHED TO THE FIRENCH SHAD ACKNOST THE BOTTOM OF THE FIRENCH SHAD ACKNOST THE BOTTOM OF THE FIRENCH SHAD SEDIMENT REMOVAL IS REQUIRED ASSOMEDANT SHALL BE REMOVED BEFORE IT HAS REACHED ONE THING THE HEIGHT OF THE FILTER FABRIC.

REVEGETATION STANDARDS

FIBER ROLLS NO SCALE

- PERMANENT REVEGETATION OR LANDSCAPING, IF REQUIRED, IS TO BE COMMENCED ON THE CONSTRUCTION SITE AS SOON AS PRACTICAL, AND IN NO CASE EXCEEDING TWELVE MONTHS AFTER ACHIEVING FINAL GRADES AND UTILITY PLACEMENTS. WHENEVER PRACTICAL, LAND IS TO BE DEVELOPED IN INCREMENTS OF WORKABLE SIZE WHICH CAN BE COMPLETED DURING A SINGLE CONSTRUCTION SEASON; EROSION CONTROL MEASURES ARE TO BE COORDINATED WITH THE SEQUENCE OF GRADING OR IMPROVEMENTS.
- ALL SURFACES DISTURBED BY VEGETATION REMOVAL, GRADING, HAUL ALL SURFACES DISTORBED BY VECLIAIN REMOVAL, GRADING, HAUL
 ROADS, OR OTHER ACTIVITY OF CONSTRUCTION WHICH ALTERS THE NATURAL
 VECETATIVE COVER ARE TO BE PREPARED FOR EXPEDIENT REVECETATION
 OR OTHERWISE MAINTAINED TO CONTROL EROSION UNLESS COVERED WITH
 IMPERVIOUS OR OTHER IMPROVED SURFACES PURSUANT TO APPROVED
 PLANS WITHIN FOURTEEN DAYS FOLLOWING THE COMPLETION OF GRADING,
 OR REMOVAL OF VEGETATION IF NO GRADING WAS INVOLVED.
- TOPSOIL REMOVED FROM THE SURFACE IN PREPARATION FOR GRADING SHALL BE RESTORED TO EXPOSE CUT AND FILL EMBANKMENTS OR BUILDING PADS SO AS TO PROVIDE A SUITABLE BASE FOR SEEDING AND
- ACCEPTABLE METHODS OF REVEGETATION INCLUDE STRAW-MULCHING, HYDRO-MULCHING OR PLANTING OF MIXTURE SPECIFIED IN THE IMPROVEMENT STANDARDS. OTHER METHODS OF REVEGETATION MAY BE APPROVED BY THE COUNTY ENGINEER WHERE EQUIVALENT PROTECTION IS
- ALL REVEGETATION AND LANDSCAPING ARE TO BE CONDUCTED WITHIN SUITABLE GROWING PERIODS. NATIVE PLANT MATERIALS ARE SPECIFICALLY ENCOURAGED IN ORDER TO REDUCE IRRIGATION DEMANDS.
- TEMPORARY SEDIMENTATION CONTROL FACILITIES ARE TO BE INSTALLED IN CONJUNCTION WITH INITIAL GRADING OPERATIONS AND MAINTAINED THE CONSTRUCTION PERIOD TO REMOVE SEDIMENTS FROM RUNOFF WATERS DURING DEVELOPMENT.
- PERMANENT SEDIMENT CATCHMENT BASINS OR OTHER TYPES OF SEDIMENT RETENTION FACILITIES ARE REQUIRED WHEREVER NECESSARY TO PREVENT DISCHARGE OF SEDIMENT INTO WATERS OF THE STATE. SEDIMENT RETENTION FACILITIES SHALL BE INSPECTED AND CLEANED ACCORDING TO A REGULAR MAINTENANCE SCHEDULE.
- THE PLANTING OR SEEDING OF VEGETATIVE PROTECTION MUST BE EFFECTIVE. IF THE VEGETATION DOES NOT GROW AND OFFER PROPER PROTECTION, IT MUST BE REPLANTED OR RESEEDED.
- THE MAINTENANCE OF VEGETATIVE PROTECTION ON GRADED SLOPES SHALL BE THE RESPONSIBILITY OF THE PERMITTEE AND SHALL BE GUARANTEED UNTIL THE VEGETATION IS WELL ESTABLISHED OR IS OFFICIALLY ASSUMED BY ANOTHER PARTY.

DUST MITIGATION PLAN

SECTION 1: FUGITIVE DUST PREVENTION AND CONTROL

LAND CLEARING/EARTH MOVING WATER SHALL BE APPLIED BY MEANS OF TRUCK(S), HOSES AND/OR SPRINKLERS PRIOR TO ANY LAND CLEARING OR EARTH MOVEMENT TO MINIMIZE DUST EMISSIONS. HAUL VEHICLES TRANSPORTING SOIL INTO OR OUT OF THE PROPERTY SHALL BE COVERED

VISIBLY DRY DISTURBED SOIL SURFACE AREAS: ALL VISIBLY DRY DISTURBED SOIL SURFACE AREAS OF OPERATION SHALL BE WATERED TO MINIMIZE DUST

PAVED ROAD TRACK-OUT:
PAVED ROADS SHALL BE CLEANED IF THE AMOUNT OF
DIRT TRACKED-OUT OF THE OPERATION AREA HAS THE
POTENTIAL TO CAUSE DUST EMISSIONS.

VISIBLY DRY DISTURBED UNPAVED DRIVEWAYS: ALL VISIBLY DRY DISTURBED UNPAYED DRIVEWAY SURFACE AREAS OF OPERATION SHALL BE WATERED TO MINIMIZE DUST EMISSIONS. UNPAYED DRIVEWAYS MAY BE GRAVELED TO REDUCE DUST EMISSIONS.

VEHICLES ENTERING / EXITING CONSTRUCTION AREA: VEHICLES ENTERING OR EXITING CONSTRUCTION AREA SHALL TRAVEL AT A SPEED WHICH MINIMIZES DUST EMISSIONS.

EMPLOYEE VEHICLES:
CONSTRUCTION WORKERS PARK IN DESIGNATED PARKING
AREA(S) TO HELP REDUCE DUST EMISSIONS.

SOIL PILE SURFACES SHALL BE MOISTENED IF DUST IS BEING EMITTED FROM THE PILE(S). ADEQUATELY SECURED TARPS, PLASTIC OR OTHER MATERIAL MAY BE REQUIRED TO FURTHER REDUCE DUST EMISSIONS. PROPRIETARY INFORMATION

THE INFORMATION CONTAINED IN THIS SET OF DRAWINGS IS PROPRIETARY BY NATURE, ANY USE OR DISCLOSURE OTHER THAN THAT WHICH RELATES TO PEEK SITE-COM IS STRICTLY PROHIBITED

CLIENT: =



5001 EXECUTIVE PKWY SAN RAMON, CA 94583

PROJECT INFORMATION:

CAMP PADREE

5001 OAK MEADOWS CT.

1	5-22-17	90% ZONING DOC'S	ALP
2	6-6-17	90% ZONING DOC'S	ALP
3	8-24-17	100% ZONING DOC'S	TAP
4	9-19-17	REV 100% ZONING DOC'S	RB
-			-
			-
			+
= C00	RDINATING EN	IGINEER:	_

Peek Site-Com 12852 Earhart Ave. Suite 101 Auburn, California 95602

Phone (530) 885-6160 E-Mail info@peeksitecom.com

SEAL: ==



SITE #: = CHK.: DRAWN BY: CM 02102

EROSION CONTROL NOTES

SHEET TITLE: -

SHEET NUMBER:

= REVISION:=

GRADING-EROSION SEDIMENT CONTROL NOTES

GRADING STANDARDS

- GENERAL UNLESS OTHERWISE RECOMMENDED IN THE APPROVED SOILS ENGINEERING OF ENGINEERING GEOLOGY REPORT, GRADING ACTIVITIES SHALL CONFORM TO THE PROVISIONS OF THIS SECTION.
- A. CUT SLOPE. THE SLOPE OF CUT SURFACES SHALL BE NO STEEPER THAN IS SAFE FOR THE INTENDED USE AND SHALL BE NO STEEPER THAN 1 UNIT VERTICAL IN 2 UNITS HORIZONTAL (50% SLOPE) UNLESS THE PERMITTEE FURNISHES A SOILS ENGINEERING OR AN ENGINEERING GEOLOGY REPORT, OR BOTH, STATING THAT THE SITE HAS BEEN INVESTIGATED AND GIVING AN OPINION THAT A CUT AT A STEEPER SLOPE WILL BE STABLE AND NOT CREATE A HAZARD TO PROPERTY OR THE ENVIRONMENT.
- B. FILL SLOPE AND PREPARATION
- (1) PREPARATION OF GROUND. THE GROUND SURFACE SHALL BE PREPARED TO RECEIVE FILL BY REMOVING VEGETATION, NON-COMPLYING FILL, TOPSOIL AND OTHER UNSUITABLE MATERIALS SCARIFYING TO PROVIDE A BOND WITH THE NEW FILL
- (2) FILL MATERIAL. AMOUNT OF ORGANIC MATERIAL DETRIMENTAL TO STRUCTURAL
 - INTEGRITY SHALL NOT BE PERMITTED IN FILLS. EXCEPT AS PERMITTED BY THE BUILDING OFFICIAL, NO ROCK OR SIMILAR IRREDUCIBLE MATERIAL WITH A MAXIMUM DIMENSION GREATER THAN 12 INCHES (0.31 M) SHALL BE BURIED OR PLACED IN FILLS.
- (3) EXCEPTION. THE BUILDING OFFICIAL MAY PERMIT PLACEMENT OF LARGER ROCK
 WHEN THE SOILS ENGINEER PROPERLY DEVISES A METHOD OF PLACEMENT, AND CONTINUOUSLY INSPECTS ITS PLACEMENT AND APPROVES THE FILL STABILITY. THE FOLLOWING CONDITIONS SHALL ALSO APPLY:
- (a) PRIOR TO ISSUANCE OF THE GRADING PERMIT, POTENTIAL ROCK DISPOSAL AREAS SHALL BE SHOWN ON THE GRADING PLAN.
- (b) ROCK SIZES GREATER THAN 12 INCHES (0.31 M) IN MAXIMUM
- DIMENSION SHALL BE 10 FEET (3.05 M) OR MORE BELOW GRADE, MEASURED VERTICALLY.
- (c) ROCKS SHALL BE PLACED SO AS TO ASSURE FILLING OF ALL VOIDS WITH
- (4) COMPACTION. ALL FILLS SHALL BE COMPACTED TO A MINIMUM OF 90 PERCENT OF MAXIMUM DRY DENSITY WITH SUFFICIENT TESTING FOR DOCUMENTATION OF COMPLIANCE WITH THIS STANDARD.
- (5) SLOPE. THE SLOPE OF FILL SURFACES SHALL BE NO STEEPER THAN IS SAFE FOR THE INTENDED USE. FILL SLOPES SHALL BE NO STEEPER THAN 1 UNIT VERTICAL IN 2 UNITS HORIZONTAL (50% SLOPE).
- a. GENERAL. CUT AND FILL SLOPES SHALL BE SET BACK FROM SITE BOUNDARIES IN
- b. ACCORDANCE WITH THIS SECTION, SETBACK DIMENSIONS SHALL BE HORIZONTAL DISTANCES MEASURED PERPENDICULAR TO THE SITE BOUNDARY.
- c. TOP OF CUT SLOPE. THE TOP OF CUT SLOPES SHALL NOT BE MADE NEARER TO A SITE
- BOUNDARY LINE THAN A MINIMUM OF 2 FEET. THE SETBACK MAY NEED TO BE INCREASED FOR ANY REQUIRED INTERCEPTOR DRAINS.
- d. TOE OF FILL SLOPE, THE TOE OF FILL SLOPE SHALL BE MADE NOT NEARER TO THE SITE
- BOUNDARY LINE THAN MINIMUM OF 2 FEET. WHERE A FILL SLOPE IS TO BE LOCATED NEAR THE SITE BOUNDARY AND THE ADJACENT OFFSITE PROPERTY IS DEVELOPED, SPECIAL PRECAUTIONS SHALL BE INCORPORATED IN THE WORK AS THE BUILDING OFFICIAL DEEMS NECESSARY TO PROTECT THE ADJOINING PROPERTY FROM DAMAGE AS A RESULT OF SUCH GRADING. THESE PRECAUTIONS MAY INCLUDE BUT ARE NOT LIMITED TO:
- (1) ADDITIONAL SETBACKS.
- (2) PROVISION FOR RETAINING, OR SLOUGH WALLS.
- (3) MECHANICAL OR CHEMICAL TREATMENT OF THE FILL SLOPE SURFACE TO MINIMIZE EROSION.
- (4) PROVISIONS FOR THE CONTROL OF SURFACE WATERS.
- e. MODIFICATION OF SETBACKS. THE BUILDING OFFICIAL MAY APPROVE ALTERNATE
- SETBACKS.THE BUILDING OFFICIAL MAY REQUIRE AN INVESTIGATION AND
- RECOMMENDATION BY A QUALIFIED ENGINEER OR ENGINEERING GEOLOGIST TO DEMONSTRATE THAT THE INTENT OF THIS SECTION HAS BEEN SATISFIED.
- 3. MAINTENANCE REQUIRED. THE PROPERTY OWNER SHALL BE RESPONSIBLE FOR ADEQUATELY MAINTAINING ALL DRAINAGE FACILITIES INSTALLED PURSUANT TO THIS SECTION.
- GRADING INSPECTION
- A. GENERAL, GRADING OPERATIONS FOR WHICH A PERMIT IS REQUIRED SHALL BE SUBJECT TO INSPECTION BY THE BUILDING OFFICIAL
- B. PERMITTEE. THE PERMITTEE SHALL BE RESPONSIBLE FOR THE WORK TO BE PERFORMED IN ACCORDANCE WITH THE APPROVED PLANS AND SPECIFICATIONS AND IN CONFORMANCE WITH THE PROVISIONS OF THIS CODE, AND THE PERMITTEE SHALL ENGAGE CONSULTANTS, IF REQUIRED, TO PROVIDE PROFESSIONAL INSPECTIONS ON A TIMELY BASIS. THE PERMITTEE SHALL ACT AS A COORDINATOR BETWEEN THE CONSULTANTS, THE CONTRACTOR AND THE BUILDING OFFICIAL. IN THE EVENT OF CHANGED CONDITIONS, THE PERMITTEE SHALL BE RESPONSIBLE FOR INFORMING THE BUILDING OFFICIAL OF SUCH CHANGE AND SHALL PROVIDE REVISED PLANS FOR APPROVAL.
- C. BUILDING OFFICIAL. THE BUILDING OFFICIAL SHALL INSPECT THE PROJECT AT THE VARIOUS STAGES OF WORK REQUIRING APPROVAL TO DETERMINE THAT ADEQUATE CONTROL IS BEING EXERCISED BY THE PROFESSIONAL CONSULTANTS.
- NOTIFICATION OF NONCOMPLIANCE. IF, IN THE COURSE OF FULFILLING THEIR RESPECTIVE DUTIES UNDER THIS CHAPTER, THE CIML ENGINEER, THE SOILS ENGINEER OR THE ENGINEERING GEOLOGIST FINDS THAT THE WORK IS NOT BEING DONE IN CONFORMANCE WITH THIS CHAPTER OR THE APPROVED GRADING PLANS, THE DISCREPANCIES SHALL BE REPORTED IMMEDIATELY IN WRITING TO THE PERMITTEE AND TO THE BUILDING OFFICIAL.
- E. TRANSFER OF RESPONSIBILITY, IF THE CIVIL ENGINEER, THE SOILS ENGINEER, OR THE ENGINEERING GEOLOGIST OF RECORD IS CHANGED DURING GRADING. THE WORK SHALL BE STOPPED UNTIL THE REPLACEMENT HAS AGREED IN WRITING TO ACCEPT THEIR RESPONSIBILITY WITHIN THE AREA OF TECHNICAL COMPETENCE FOR APPROVAL UPON COMPLETION OF THE WORK. IT SHALL BE THE DUTY OF THE PERMITTEE TO NOTIFY THE BUILDING OFFICIAL IN WRITING OF SUCH CHANGE PRIOR TO THE RE-COMMENCEMENT OF SUCH GRADING.
- EROSION AND SEDIMENTATION CONTROL
- A. ADMINISTRATION
- (1) THE EROSION AND SEDIMENT CONTROL PROVISIONS OF THIS SECTION SHALL BE APPLICABLE TO ALL FACILITIES AND ACTIVITIES UNDER THE SUPERVISION OF THE DIRECTOR OF THE DEPARTMENT OF PUBLIC WORKS.
- (2) THE ADMINISTRATION OF THIS SECTION, AS IT AFFECTS COUNTY FACILITIES AND ACTIVITIES, IS THE RESPONSIBILITY OF THE DIRECTOR OF THE DEPARTMENT OF PUBLIC WORKS
- (3) THE ADMINISTRATION OF THIS SECTION AS IT AFFECTS OTHER BUILDING, GRADING, AND RELATED ACTIVITIES IS THE RESPONSIBILITY OF THE CHIEF BUILDING OFFICIAL
- (4) ANY SOILS OR GEOLOGIC REPORTS PREPARED FOR ANY PROJECT WHERE A GRADING PERMIT IS SUBMITTED AS A PART OF A TENTATIVE SUBDIVISION MAP APPLICATION, OR RELATED ENVIRONMENTAL DOCUMENT, SHALL BE PLACED IN THE RECORDS OF THE CHIEF BUILDING OFFICIAL.
- B. EROSION AND SEDIMENTATION CONTROL. THESE MINIMUM EROSION AND SEDIMENTATION CONTROL STANDARDS SHALL APPLY TO ALL PROJECTS REQUIRING BUILDING, GRADING, AND DEVELOPMENT PERMITS, AND COUNTY OF MENDOCINO PUBLIC WORKS ACTIVITIES, TO PREVENT SEDIMENTATION OR DAMAGE TO ONSITE AND OFFSITE PROPERTY. THESE STANDARDS SHALL BE INCORPORATED INTO THE PROJECT DESIGN AND SHALL BE ADHERED TO DURING PROJECT CONSTRUCTION:

(1) GENERAL GUIDELINES

- (a) MINIMIZE SOIL EXPOSURE DURING THE RAINY SEASON BY PROPER TIMING OF GRADING AND CONSTRUCTION.
- (b) RETAIN TREES AND NATURAL VEGETATION TO STABILIZE HILLSIDES, RETAIN MOISTURE, REDUCE EROSION, MINIMIZE SILTATION AND NUTRIENT RUNOFF AND PRESERVE SCENIC QUALITIES.
- (c) VEGETATE AND MULCH DENUDED AREAS TO PROTECT THEM FROM WINTER RAINS.
- (d) DIVERT RUNOFF AWAY FROM STEEP, DENUDED SLOPES OR OTHER CRITICAL AREAS WITH BARRIERS, BERMS, DITCHES OR OTHER FACILITIES.
- (e) LIMIT CONSTRUCTION, CLEARING OF VEGETATION AND DISTURBANCE OF THE SOIL TO AREAS OF PROVEN STABILITY. MITIGATE GEOLOGIC HAZARDS AND ADVERSE SOIL CONDITIONS WHEN THEY ARE ENCOUNTERED.
- (f) REDUCE SEDIMENT TRANSPORT OFF THE SITE TO THE MAXIMUM EXTENT FEASIBLE THROUGH THE USE OF BEST MANAGEMENT PRACTICES (BMPS)

- (g) PROPOSE A NEW OR MODIFIED EROSION AND SEDIMENT CONTROL TECHNIQUE IF THE TECHNIQUE IS PREFERRED AND MEETS THE INTENT OF THESE REGULATIONS. OBTAIN APPROVAL FROM THE COUNTY PRIOR TO IMPLEMENTATION
- (h) CONDUCT FREQUENT SITE INSPECTIONS TO ENSURE THAT CONTROL MEASURES ARE WORKING PROPERLY AND TO CORRECT PROBLEMS AS NEEDED.
- (i) EMPLOY OTHER MEANS OF EROSION AND SEDIMENT CONTROL AS REQUIRED BY THE CHIEF BUILDING OFFICIAL OR DIRECTOR OF THE DEPARTMENT OF PUBLIC WORKS

(2) SEDIMENT CONTROL

- (a) USE SEDIMENT BASINS, SILT TRAPS, OR SIMILAR MEASURE TO RETAIN SEDIMENT TRANSPORTED BY RUNOFF WATER ONSITE.
- (b) COLLECT AND DIRECT SURFACE RUNOFF AT NON-EROSIVE VELOCITIES TO THE COMMON NATURAL WATERCOURSE OF THE DRAINAGE AREA.
- (c) AVOID CONCENTRATING SURFACE WATER ANYWHERE EXCEPT SWALES OR WATERCOURSES.
- (d) PREVENT MUD FROM BEING TRACKED ONTO THE PUBLIC ROADWAY BY TRAVELING OVER A TEMPORARY GRAVEL CONSTRUCTION ENTRANCE OR WASHING OFF VEHICLE TIRES BEFORE ENTERING A PUBLIC OR PRIVATE DRIVEWAY.

(3) SLOPE CONSTRUCTION

- (a) MINIMIZE LENGTH AND STEEPNESS OF SLOPES BY BENCHING, TERRACING OR CONSTRUCTING DIVERSION STRUCTURES.
- (b) PRESERVE, MATCH, OR BLEND CUTS AND FILLS WITH THE NATURAL CONTOURS AND UNDULATIONS OF THE LAND.
- (c) ROUND SHARP ANGLES AT THE TOP AND SIDES OF CUT AND FILL SLOPES.
- (d) MAINTAIN CUT AND FILL SLOPES AT LESS THAN TWO-TO-ONE (2:1, RUN:RISE) SLOPE UNLESS A GEOLOGICAL AND ENGINEERING ANALYSIS INDICATES THAT STEEPER SLOPES ARE SAFE AND EROSION AND SEDIMENT CONTROL MEASURES CAN SUCCESSFULLY PREVENT EROSION.

(4) PROTECTION OF WATERCOURSES AND DRAINAGE INLETS

- (a) PREPARE DRAINAGEWAYS TO HANDLE CONCENTRATED OR INCREASED RUNOFF FROM DISTURBED AREAS BY USING APPROPRIATE LINING MATERIALS OR ENERGY ABSORBING DEVICES TO REDUCE THE VELOCITY OF RUNOFF WATER.
- (b) TRAP SEDIMENT-LADEN RUNOFF IN BASINS TO ALLOW SOIL PARTICLES TO SETTLE OUT BEFORE FLOWS ARE RELEASED TO RECEIVING WATERS, STORM DRAINS, STREETS OR ADJACENT PROPERTY. THIS STANDARD IS NOT MANDATORY FOR GRADING THE SITE IS FULLY WINTERIZED AND STABILIZED PRIOR TO AND WHEN CONDUCTED BETWEEN APRIL 15 AND OCTOBER 15 OCTOBER 15. REMOVE TRAPPED SEDIMENT TO A SUITABLE LOCATION ON-SITE OR AT A DISPOSAL SITE
- (c) DO NOT GRADE OR DRIVE EQUIPMENT IN A STREAMSIDE MANAGEMENT OR OTHER WET AREAS EXCEPT AS ALLOWED THROUGH THE COUNTY STREAMSIDE MANAGEMENT AREA ORDINANCE.
- (d) DEPOSIT OR STORE EXCAVATED MATERIALS AWAY FROM WATERCOURSES.
- (e) PROTECT ALL EXISTING OR NEWLY INSTALLED STORM DRAINAGE STRUCTURES FROM SEDIMENT CLOGGING.
- (f) (F) USE STRAW BALES, FILTER FABRIC WRAPS AND DRAINAGE INLET PROTECTIONS IN A MANNER THAT DOES NOT CAUSE ADDITIONAL EROSION OR FLOODING OF A ROADWAY.

(5) DISPOSAL OF EXCAVATED MATERIALS


- (a) STOCKPILE TOPSOIL ON THE SITE FOR USE ON AREAS TO BE REVEGETATED.
- (b) PLACE STOCKPILED SOIL IN LOCATIONS, SO THAT IF EROSION OCCURS, IT WILL NOT CONTRIBUTE TO OFFSITE SEDIMENT DISCHARGE
- (e) PROTECT STOCKPILED SOIL PROMPTLY THROUGH THE USE OF APPROPRIATE BMPS TO REDUCE THE RISK OF EROSION AND SEDIMENT TRANSPORT. APPLY MULCH OR OTHER PROTECTIVE COVERINGS ON STOCKPILED MATERIAL THAT WILL BE EXPOSED THROUGH THE WINTER SEASON.
- (d) DISPOSE OF EXCAVATED MATERIAL NOT USED AT THE SITE AT A LOCATION APPROVED BY THE COUNTY.

(6) DUST CONTROL

- (o) ALL CONSTRUCTION AREAS, INCLUDING DISPOSAL SITES, SHALL BE TREATED AND MAINTAINED AS NECESSARY TO MINIMIZE THE EMISSION OF DUST. MAINTENANCE SHALL BE CONDUCTED AS NECESSARY TO PREVENT A NUISANCE TO OFFSITE PROPERTIES.
- (b) ALL CONSTRUCTION SITES, INCLUDING DRIVEWAYS, SHALL BE MAINTAINED AS NECESSARY TO MINIMIZE THE EMISSION OF DUST AND PREVENT THE CREATION OF A NUISANCE TO ADJACENT PROPERTIES.

(7) REVEGETATION

- (a) APPLY TEMPORARY SEEDING AND MULCHING TO DENUDED AREAS PRIOR TO OCTOBER 15 UNLESS THE PROJECT IS CONDITIONED OTHERWISE.
- (b) ESTABLISH A PERMANENT VEGETATIVE COVER ON DENUDED AREAS NOT OTHERWISE STABILIZED. PERMANENT VEGETATION GROUND COVER MUST CONTROL SOIL EROSION SATISFACTORILY AND SURVIVE SEVERE WEATHER CONDITIONS.
- (c) RETAIN A VEGETATIVE BARRIER WHENEVER POSSIBLE AROUND PROPERTY BOUNDARIES.
- (d) USE SELF-SUSTAINING, NON-INVASIVE PLANTS THAT REQUIRE LITTLE OR NO MAINTENANCE AND DO NOT CREATE AN EXTREME FIRE HAZARD.
- (e) USE NATIVE PLANT SPECIES WHENEVER FEASIBLE.

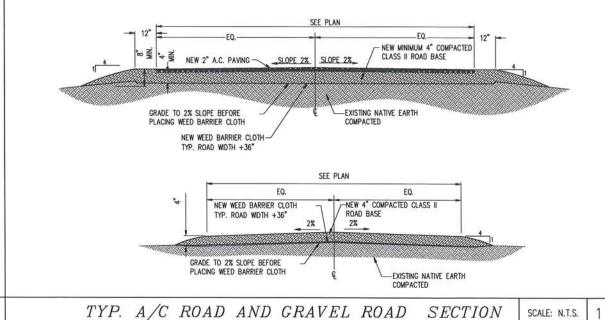

PROPRIETARY INFORMATION

HE INFORMATION CONTAINED IN THIS SET OF DRAWINGS IS PROPRIETARY BY NATURE. ANY USE OR DISCLOSURE OTHER THAN THAT WHICH RELATES TO PEEK SITE-COM IS STRICTLY PROHIBITED

CLIENT: =



5001 EXECUTIVE PKWY SAN RAMON, CA 94583

PROJECT INFORMATION: =

CAMP PADREE

REV: = DATE: === == DESCRIPTION: ===

= RY-

5-22-17 90% ZONING DOC'S ALP 6-6-17 90% ZONING DOC'S ALP 8-24-17 100% ZONING DOC'S TAP 9-19-17 REV 100% ZONING DOC'S RB COORDINATING ENGINEER:=

> 12852 Earhart Ave. Suite 101 Auburn, California 95602 Phone (530) 885-6160

Peek Site-Com

E-Mail info@peeksitecom.com

SEAL: =




SITE # = CHK.: DRAWN BY: : CM 02102 SHEET TITLE: =

GRADING NOTES & DETAILS

SHEET NUMBER:

= REVISION:=

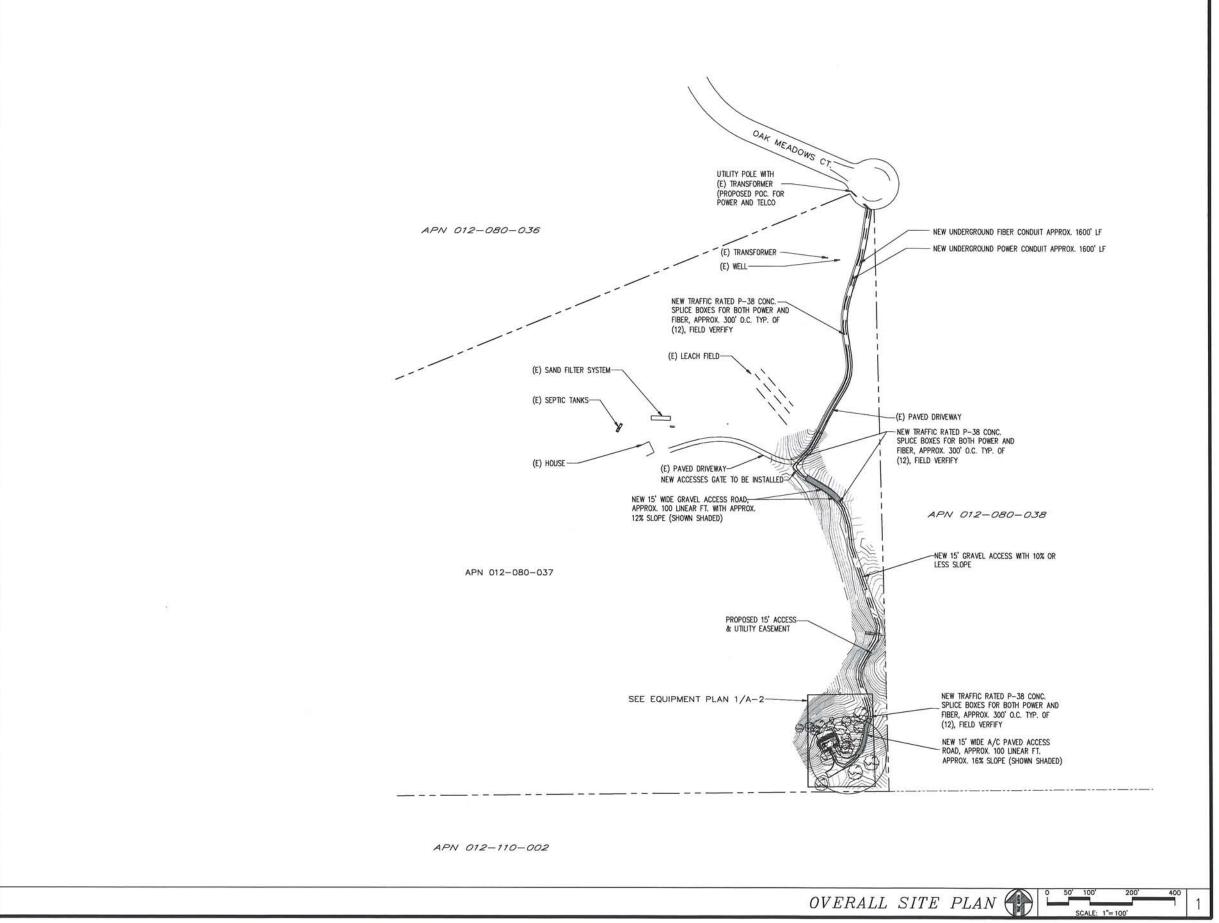

PROPRIETARY INFORMATION

THE INFORMATION CONTAINED IN THIS
SET OF DRAWINGS IS PROPRIETARY
BY NATURE. ANY USE OR
DISCLOSURE OTHER THAN THAT WHICH
RELATES TO PEEK SITE-COM IS
STRICTLY PROHIBITED

CLIENT: =



5001 EXECUTIVE PKWY SAN RAMON, CA 94583

PROJECT INFORMATION:

CAMP PADREE

5001 OAK MEADOWS CT. IONE , CA 95640

REV:	= DATE: ==	DESCRIPTION:	BY
1	5-22-17	90% ZONING DOC'S	ALP
2	6-6-17	90% ZONING DOC'S	ALP
3	8-24-17	100% ZONING DOC'S	TAP
4	9-19-17	REV 100% ZONING DOC'S	RB
-			+
			_
_			_
-			+-
			+
-			_

COORDINATING ENGINEER:

Peek Site-Com 12852 Earhart Ave. Suite 101 Auburn, California 95602 Phone (530) 885-6160

E-Mail info@peeksitecom.com




CHK.: DRAWN BY: = CVL02102

OVERALL SITE PLAN

SHEET NUMBER:

SHEET TITLE: =

== REVISION:==

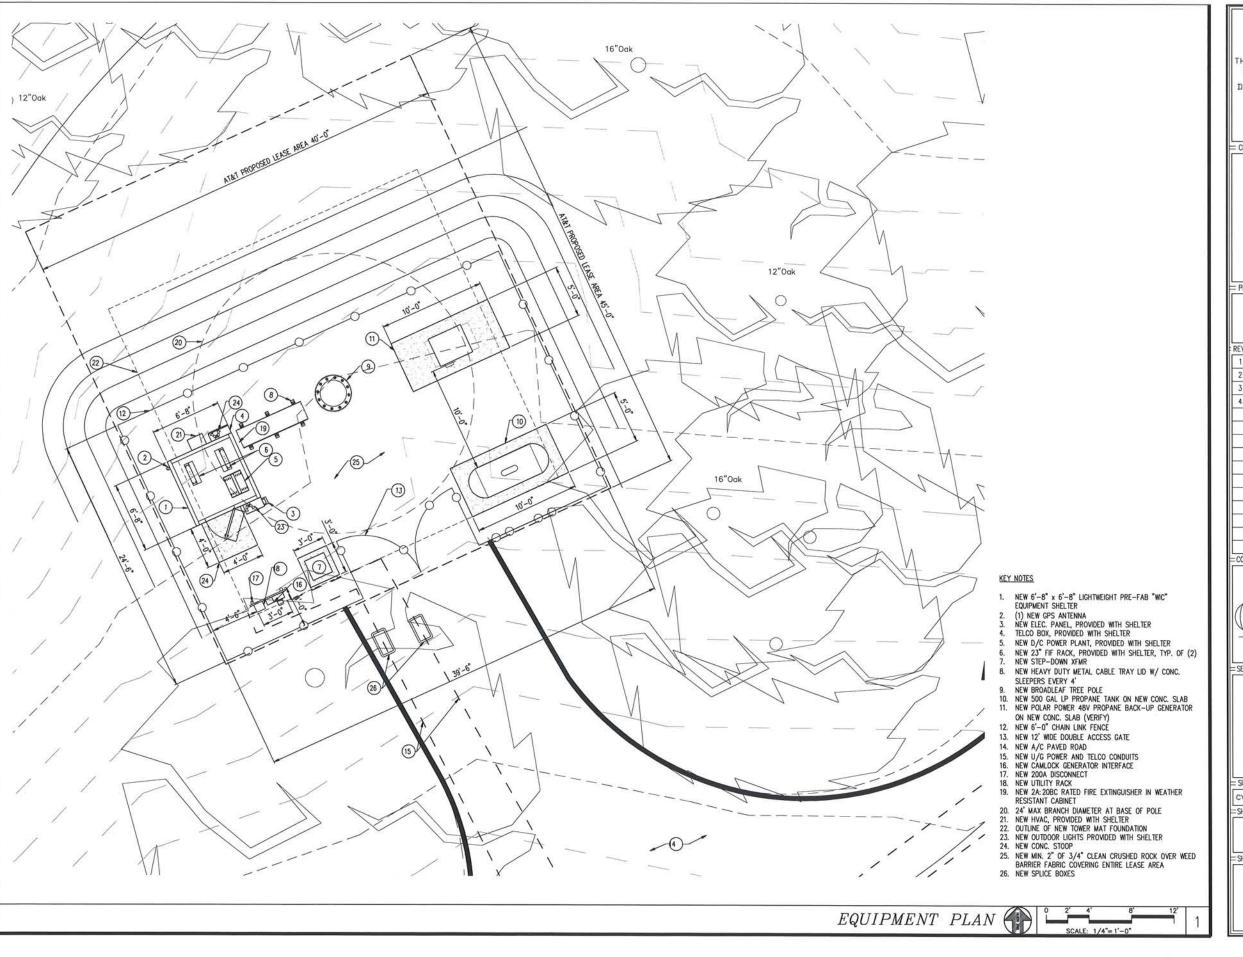

PROPRIETARY INFORMATION

THE INFORMATION CONTAINED IN THIS
SET OF DRAWINGS IS PROPRIETARY
BY NATURE. ANY USE OR
DISCLOSURE OTHER THAN THAT WHICH
RELATES TO PEEK SITE-COM IS
STRICTLY PROHIBITED

= CLIENT: ==



5001 EXECUTIVE PKWY SAN RAMON, CA 94583

PROJECT INFORMATION:

CAMP PADREE

5001 OAK MEADOWS CT. IONE , CA 95640

REV:	= DATE: ==	DESCRIPTION:	BY:
1	5-22-17	90% ZONING DOC'S	ALP
2	6-6-17	90% ZONING DOC'S	ALP
3	8-24-17	100% ZONING DOC'S	TAP
4	9-19-17	REV 100% ZONING DOC'S	RB
			+-
			+
			+

Peek Site-Com

12852 Earhart Ave. Suite 101 Auburn, California 95602 Phone (530) 885–6160

Auburn, California 95602 Phone (530) 885-6160 E-Mail info@peeksitecom.com

EAL: ====



SITE #: _____ CHK.: ____ DRAWN BY: __

CVL02102 ... ALP


EQUIPMENT PLAN


=SHEET NUMBER:=


REVISION:

A-2

(

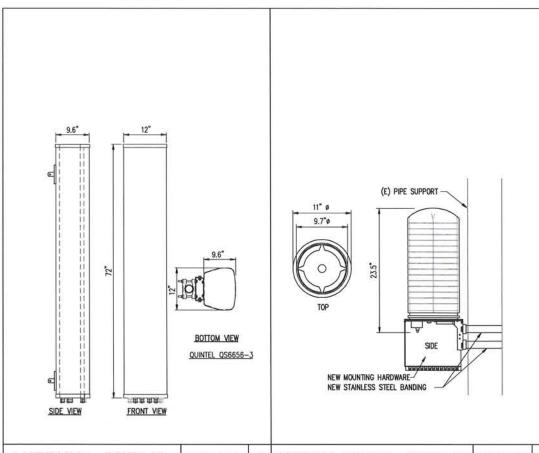

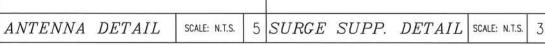

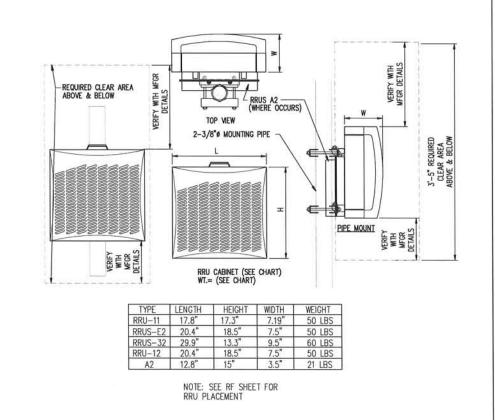


RRU DETAIL

SCALE: N.T.S.

RF SCHEDULE

SECTOR/POS.	ANTENNA MODEL	RAD CENTER	PHYSICAL AZIMUTH	RRU	TMA	FIBER LENGTH	COAX LENGTH	COAX DIA.	NO.
A/1	QS6656-3	72'	90'	(1) RRUS-11 & (1) RRUS-32 B2	N/A	± 180"	± N/A	N/A	(2)
A/2	QS6656-3	72'	90"	(1) RRUS-32 B30	N/A	± 180°	± N/A	N/A	177
A/3	QS6656-3	62'	90*	(1) RRUS-11	N/A	± 190°	± N/A	N/A	-
A/4	QS6656-3	62'	90°	(1) RRUS-11 & RRUS-32 B2	N/A	± 190°	± N/A	N/A	-
B/1	QS6656-3	72'	330	(1) RRUS-11 & (1) RRUS-32 B2	N/A	± 180°	± N/A	N/A	-
B/2	QS6656-3	72'	330	(1) RRUS-32 B30	N/A	± 180°	± N/A	N/A	-
B/3	QS6656-3	62'	330	(1) RRUS-11	N/A	± 190'	± N/A	N/A	140
B/4	QS6656-3	62'	330	(1) RRUS-11 & RRUS-32 B2	N/A	± 190°	± N/A	N/A	-
C/1	QS6656-3	72'	210	(1) RRUS-11 & (1) RRUS-32 B2	N/A	± 180°	± N/A	N/A	-
C/2	QS6656-3	72'	210	(1) RRUS-32 B30	N/A	± 180°	± N/A	N/A	-
C/3	QS6656-3	62'	210	(1) RRUS-11	N/A	± 190°	± N/A	N/A	12
C/4	QS6656-3	62'	210"	(1) RRUS-11 & RRUS-32 B2	N/A	± 190°	± N/A	N/A	-

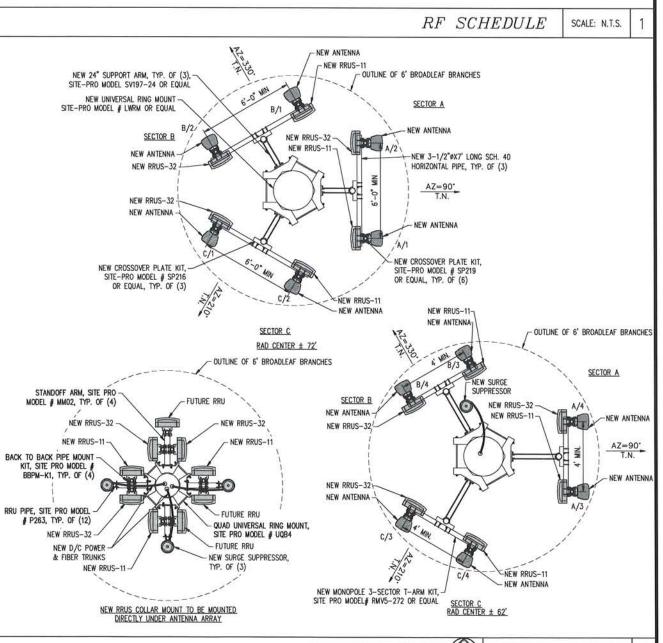

ANTENNA PLAN

PROPRIETARY INFORMATION

THE INFORMATION CONTAINED IN THIS
SET OF DRAWINGS IS PROPRIETARY
BY NATURE. ANY USE OR
DISCLOSURE OTHER THAN THAT WHICH
RELATES TO PEEK SITE-COM IS
STRICTLY PROHIBITED

= CLIENT: =



5001 EXECUTIVE PKWY SAN RAMON, CA 94583

PROJECT INFORMATION:

CAMP PADREE

5001 OAK MEADOWS CT. IONE , CA 95640

REV:	= DATE: ===	DESCRIPTION:	==
1.	5-22-17	90% ZONING DOC'S	Al
2	6-6-17	90% ZONING DOC'S	Al
3	8-24-17	100% ZONING DOC'S	TA
4	9-19-17	REV 100% ZONING DOC'S	R
			+
_			
			+
_			-
		IGNEER:	

 $Peek\ Site-Com$

12852 Earhart Ave. Suite 101 Auburn, California 95602 Phone (530) 885-6160

E-Mail info@peeksitecom.com



SITE #: CHK.: DRAWN BY: =

CVL02102 ... ALP

ANTENNA PLAN &
DETAILS


SHEET NUMBER:


A-3

SCALE: 3/8"=1'-0"

C

= REVISION:=

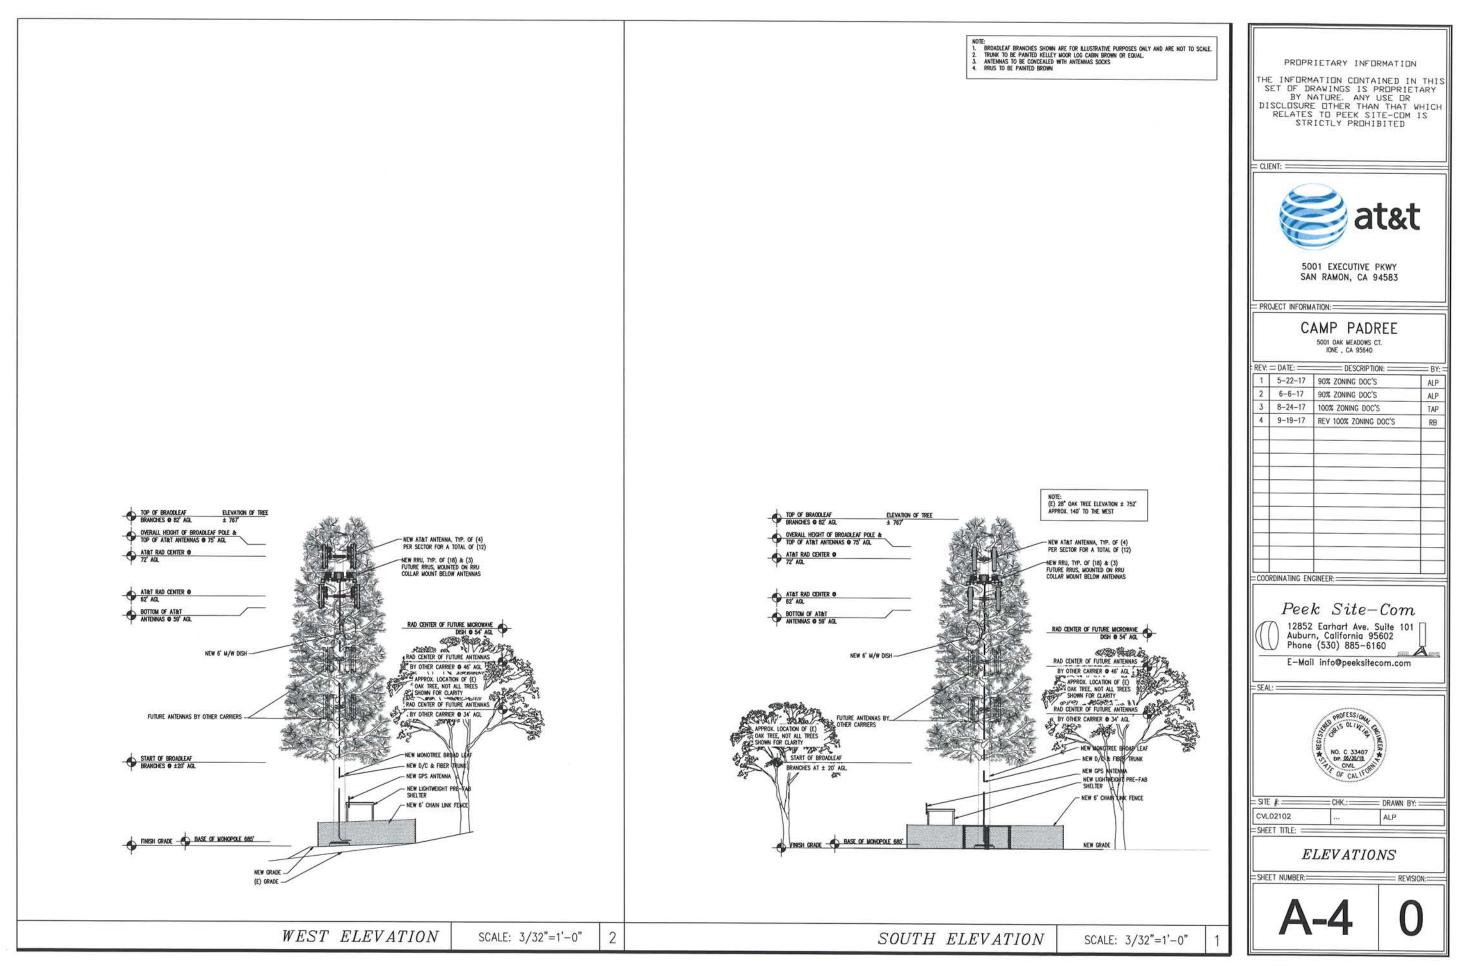

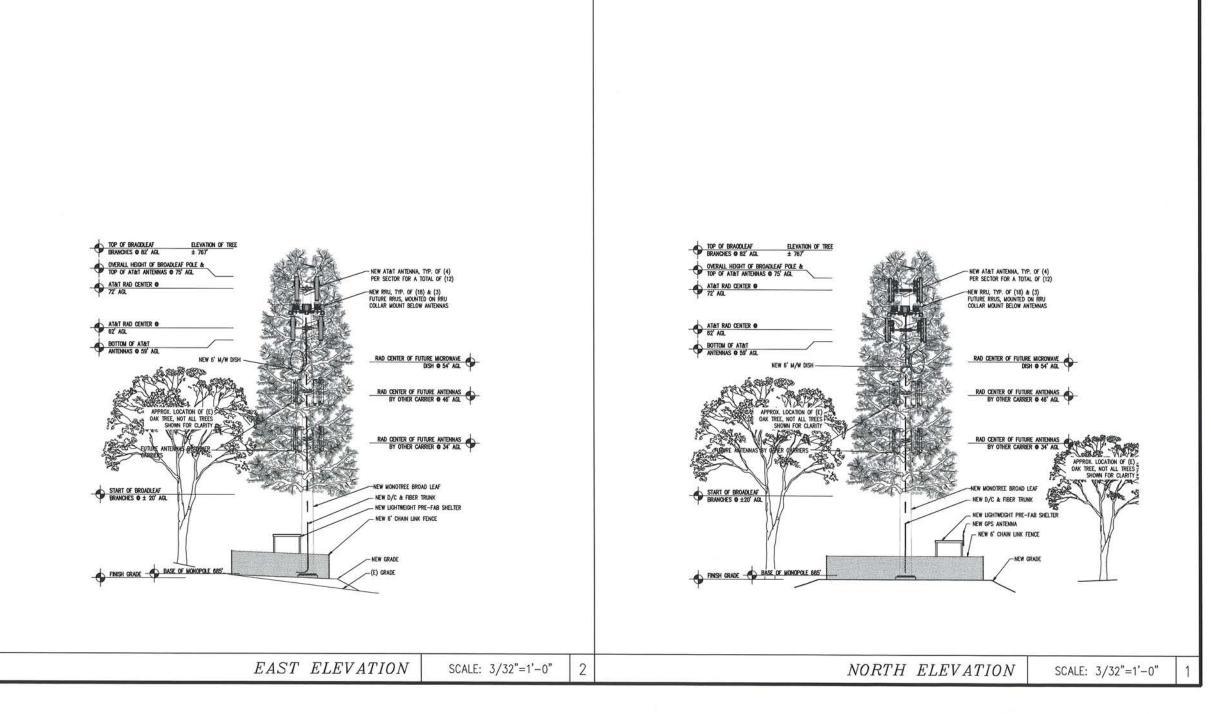

PROPRIETARY INFORMATION

THE INFORMATION CONTAINED IN THIS
SET OF DRAWINGS IS PROPRIETARY
BY NATURE. ANY USE OR
DISCLOSURE DITHER THAN THAT WHICH
RELATES TO PEEK SITE-COM IS
STRICTLY PROHIBITED

CLIENT:

NOTE:

1. BROADLEAF BRANCHES SHOWN ARE FOR ELUSTRATIVE PURPOSES ONLY AND ARE NOT TO SCALE.

2. TRUNK TO BE PAWIED KELLEY MOOR LOG CABM BROWN OR EQUAL.

3. ANTENNAS TO BE CONCEALED WITH ANTENNAS SOCKS.

4. RRUS TO BE PAWIED BROWN



5001 EXECUTIVE PKWY SAN RAMON, CA 94583

PROJECT INFORMATION:

CAMP PADREE

5001 OAK MEADOWS CT. IONE , CA 95640

REV:	= DATE: ==	DESCRIPTION:	BY
1	5-22-17	90% ZONING DOC'S	ALF
2	6-6-17	90% ZONING DOC'S	ALP
3	8-24-17	100% ZONING DOC'S	TAP
4	9-19-17	REV 100% ZONING DOC'S	RB
			+
_			
			+

= COORDINATING ENGINEER:=



E-Mail info@peeksitecom.com

PROFESS/Quarter Solver Solver

SHEET TITLE:

ELEVATIONS

A-4.1

0

== REVISION:==