

# AMADOR COUNTY TRANSPORTATION AND PUBLIC WORKS PUBLIC WORKS COMMITTEE MEETING AGENDA

**Conference Room D** 

**Tuesday January 4, 2022** 

1:00pm

(Supervisors Oneto and Crew)

In compliance with the Americans with Disabilities Act, if you are a person with a disability and you need a modification or accommodation to participate in this meeting, please contact the Public Works Department at (209) 223-6429 or (209) 223-6395 (fax). Requests must be made as early as possible, and at least one full business day before the meeting.

#### **CALL TO ORDER**

**AGENDA:** Approval of agenda for this date. Any and all off-agenda items must be approved by the Committee.

<u>PUBLIC MATTERS NOT ON THE AGENDA</u>: Discussion items only, no action to be taken. Any person may address the Committee at this time upon any subject within the jurisdiction of the Public Works Committee; however, any matter that requires action may be referred to staff and/or Committee for a report and recommendation for possible action at a subsequent Committee meeting. Please note – there is a five (5) minute limit per topic.

**MINUTES:** Approval of Minutes from December 14, 2021 meeting.

#### **ITEMS**:

1. Discussion of Utilization of PGE Rule 20 Credit Proceeds Review of Proposed Public Works Crew Quarters

#### **TOPICS FOR NEXT MEETING:**

For Discussion

#### **NEXT MEETING:**

Tuesday March 8, 2022 1 PM

#### **ADJOURNMENT:**



# AMADOR COUNTY TRANSPORTATION AND PUBLIC WORKS PUBLIC WORKS COMMITTEE MEETING MINUTES

#### **MEETING DATE AND TIME:**

December 14, 2021, 1:00 pm

#### **ATTENDEES:**

Supervisor Crew, District 1 Supervisor Oneto, District 5 Richard Vela, Public Works Director

#### **CALL TO ORDER:**

The meeting was called to order by Supervisor Oneto at 3:15 pm.

#### **AGENDA:**

The agenda was approved as posted.

#### **PUBLIC MATTERS NOT ON THE AGENDA:**

None.

#### MINUTES:

Motion by Oneto, second by Crew, to approve the minutes of the April 20, 2021 was carried.

#### **ITEMS**:

#### 1. Camanche Village Drive Extension to Highway 88

Public Works Director Vela presented the Committee an update on the proposal of extending Village Drive from the Camanche Village area to SR 88, brought about by the proposed development of Camanche Village Unit 3B. The Developer has withdrawn the proposal for the second access and is moving forward with the development as originally approved in 1973.

Larry Patterson, a resident in the Camanche area, was present to voice his concern with the elimination of a second access to serve the proposed development. He raised concerns with fire/life safety aspects with not having a second access to serve the proposed development.

# 2. Review of Ordinance from Lake County concerning Permitting of Temporary Dwellings and possible direction for modification for consideration by Amador County

The Board of Directors (BOS) has discussed the issue of placement and occupancy of recreational vehicles as temporary dwellings. Referenced in the discussion was a policy developed by the County of Lake for the permitting the temporary dwellings while recovering

Amador County Transportation and Public Works Public Works Committee Meeting Minutes December 14, 2021 Page 2 of 3

from the Valley Fire in 2015. The BOS requested the Public Works Committee to review the County of Lake policy and provide direction for the modification of the policy for possible consideration by the BOS.

The Committee discussed the merits of the policy and was generally OK with the policy. The Committee felt that an annual permit renewal would be appropriate. The Committee raised the question whether generator usage would be allowed. These considerations will go the BOS for discussion.

#### 3. Waiver of Encroachment Permit Fees

The Committee discussed the discretion of waiving fees for encroachment permits. The Committee felt that the Public Works Director should use his/her discretion in the waiver of fees for encroachment permits, not requiring Board of Supervisors action.

For the purpose of clarity and consistency, the following policy or guidelines are to be followed for the waiver of fees for encroachment permits:

- Fees may be waived for special events sponsored by non-profit organizations for fund raising or community event purposes.
- Fees may be waived for other governmental agencies within Amador County. These
  requests are few and far between and this gesture is made in the spirit of cooperation
  with these agencies.

#### 4. Change Order Authorization for Public Works Contracts

Public Works Director Vela outlined a proposal for the handling of minor change orders on public works contracts to be done at the Department level by the Director, similar to contracts administered by the General Services Administration (GSA) where the construction/project manager can approve changes in the contract price effected by a change order for amounts not to exceed \$5,000 per modification or in the aggregate 5% of the contract amount.

For public works projects, the following language is proposed to be included appropriately in the public works contract specifications under Section 4-1.05, Changes and Extra Work:

Alterations, modifications or extras that result in a change in the Contract Price or Contract Time, or both, shall be effected by a written Contract Modification and/or Change Order that has been approved by the Engineer and signed by the Director for amounts not to exceed \$5,000 per modification or in the aggregate 5% of the Contract Price. Modifications in excess of those amounts must be approved by the Board of Supervisors. Those alterations or modifications that do not result in a change in the Contract Price or Contract Time, and do not substantially change the Work, shall be effected only by a written directive to Contractor from the Engineer.

The Committee expressed support for this proposal and directed Director Vela to have this item brought before the Board of Supervisors for consideration under a regular agenda item.

Amador County Transportation and Public Works Public Works Committee Meeting Minutes December 14, 2021 Page 3 of 3

#### 5. Engineering and Traffic Survey (Speed Study) Requests

While the Department has the authority to administer allocated budgeted funds as necessary throughout the fiscal year for Engineering and Traffic Surveys, perhaps more commonly referred to as speed studies, staff is requesting whether the Public Works Committee wishes to review these requests to provide staff with guidance on whether to have surveys/studies performed. The Committee provided the following direction: attempt to bunch requests together and take them to the Board of Supervisors for consideration.

#### 6. Discussion of Utilization of PG&E Rule 20 Credit Proceeds

The Committee continued discussion of the proposed plan for fund utilization in the event the Transportation and Public Works Department is the recipient of all or part of the \$1.9M proceeds from the sale of the PG&E Rule 20 credit sale. Taking into consideration the Committee's stated support for the new public works crew quarters and a greater emphasis on the remaining funds to go towards the road reconstruction/rehabilitation with a lesser emphasis on vehicle replacement. After discussion, the proposed breakdown on the utilization of the \$1.9M would be as follows: \$250,000 toward the new crew quarters, \$300,000 toward heavy-duty diesel vehicle replacement (matching allocated SB1 funds) and the remaining \$1,350,000 toward road reconstruction/rehabilitation.

The Committee wished to revisit the plans for the new crew quarters. Public Works Director Vela will provide the building plans to the Committee for a follow up discussion at the next Committee meeting.

#### **TOPICS FOR NEXT MEETING:**

1. Continued discussion on the PG&E Rule 20 credit proceeds, in particular the allocation for the new public works crew quarters. Public Works Director Vela will provide plans for the proposed building.

#### **NEXT MEETING:**

January 4, 2022, 1 pm.

The Committee recommended a bi-monthly meeting schedule with meetings occurring after the first BOS meeting of that month.

**ADJOURNMENT:** The meeting was adjourned at 4:45 pm.



#### AMADOR COUNTY COMMUNITY DEVELOPMENT AGENCY

#### TRANSPORTATION & PUBLIC WORKS

FAX: (209) 223-6395 WEBSITE: www.amadorgov.org

PHONE: (209) 223-6429

EMAIL: PublicWorks@amadorgov.org

COUNTY ADMINISTRATION CENTER • 810 COURT STREET • JACKSON, CA 95642-2132

#### **PUBLIC WORKS COMMITTEE MEETING DATE: January 4, 2022**

#### **AGENDA ITEM 1**

To: **Public Works Committee** 


From: Richard Vela, Public Works Director


Subject: Discussion of Utilization of PG&E Rule 20 Credit Proceeds


**Review of Proposed Public Works Crew Quarters** 

At its December 14, 2021 meeting, the Public Works Committee continued discussion of the proposed plan for fund utilization in the event the Transportation and Public Works Department is the recipient of all or part of the \$1.9M proceeds from the sale of the PG&E Rule 20 credit sale. Taking into consideration the Committee's stated support for the new public works crew quarters and a greater emphasis on the remaining funds to go towards the road reconstruction/rehabilitation with a lesser emphasis on vehicle replacement. After discussion, the proposed breakdown on the utilization of the \$1.9M would be as follows: \$250,000 toward the new crew quarters, \$300,000 toward heavy-duty diesel vehicle replacement (matching allocated SB1 funds) and the remaining \$1,350,000 toward road reconstruction/rehabilitation.

The Committee wished to revisit the plans for the new crew quarters for a follow up discussion at the next Committee meeting In January 2022. Enclosed is the plan set for the crew quarters facilities that was bid out in January 2020. The proposed building is approximately 800 SF which includes an assembly area, a locker room and two restrooms.

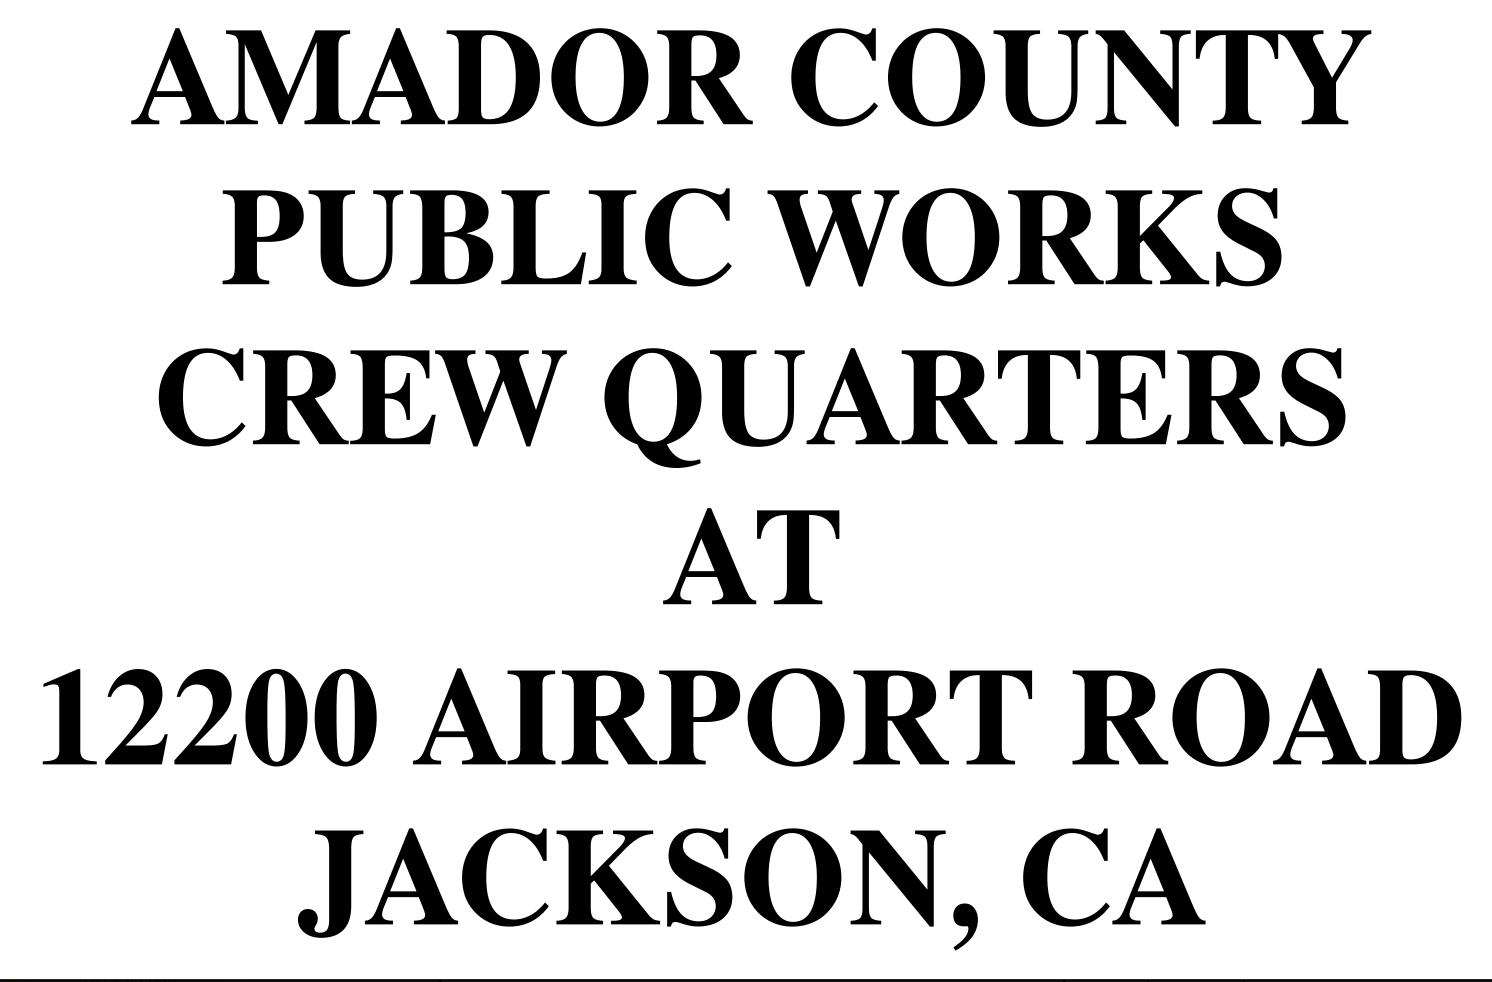

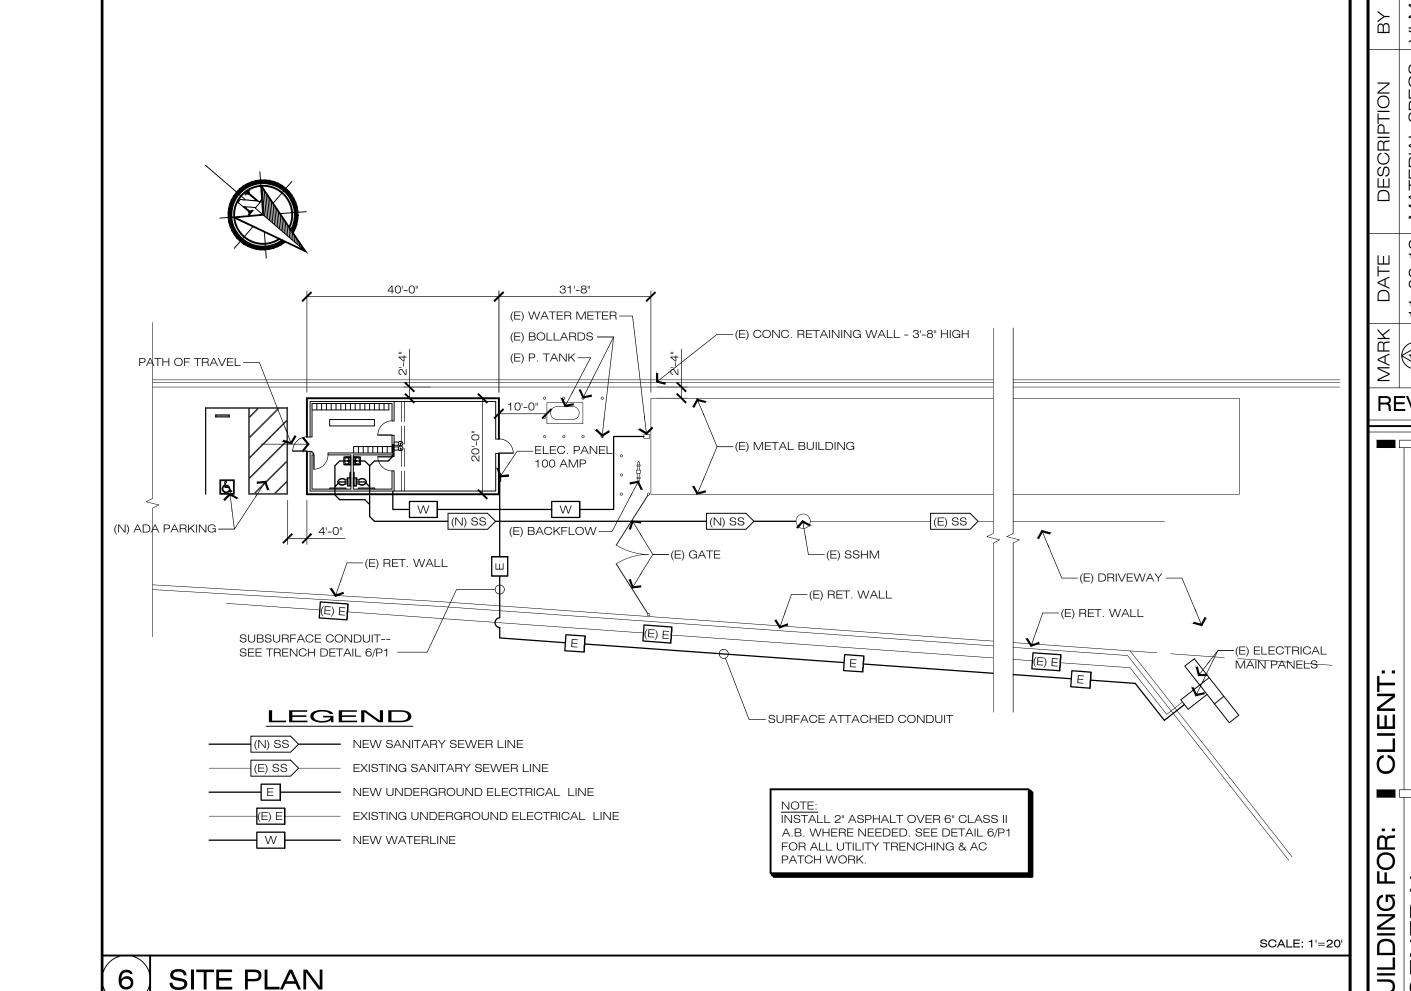

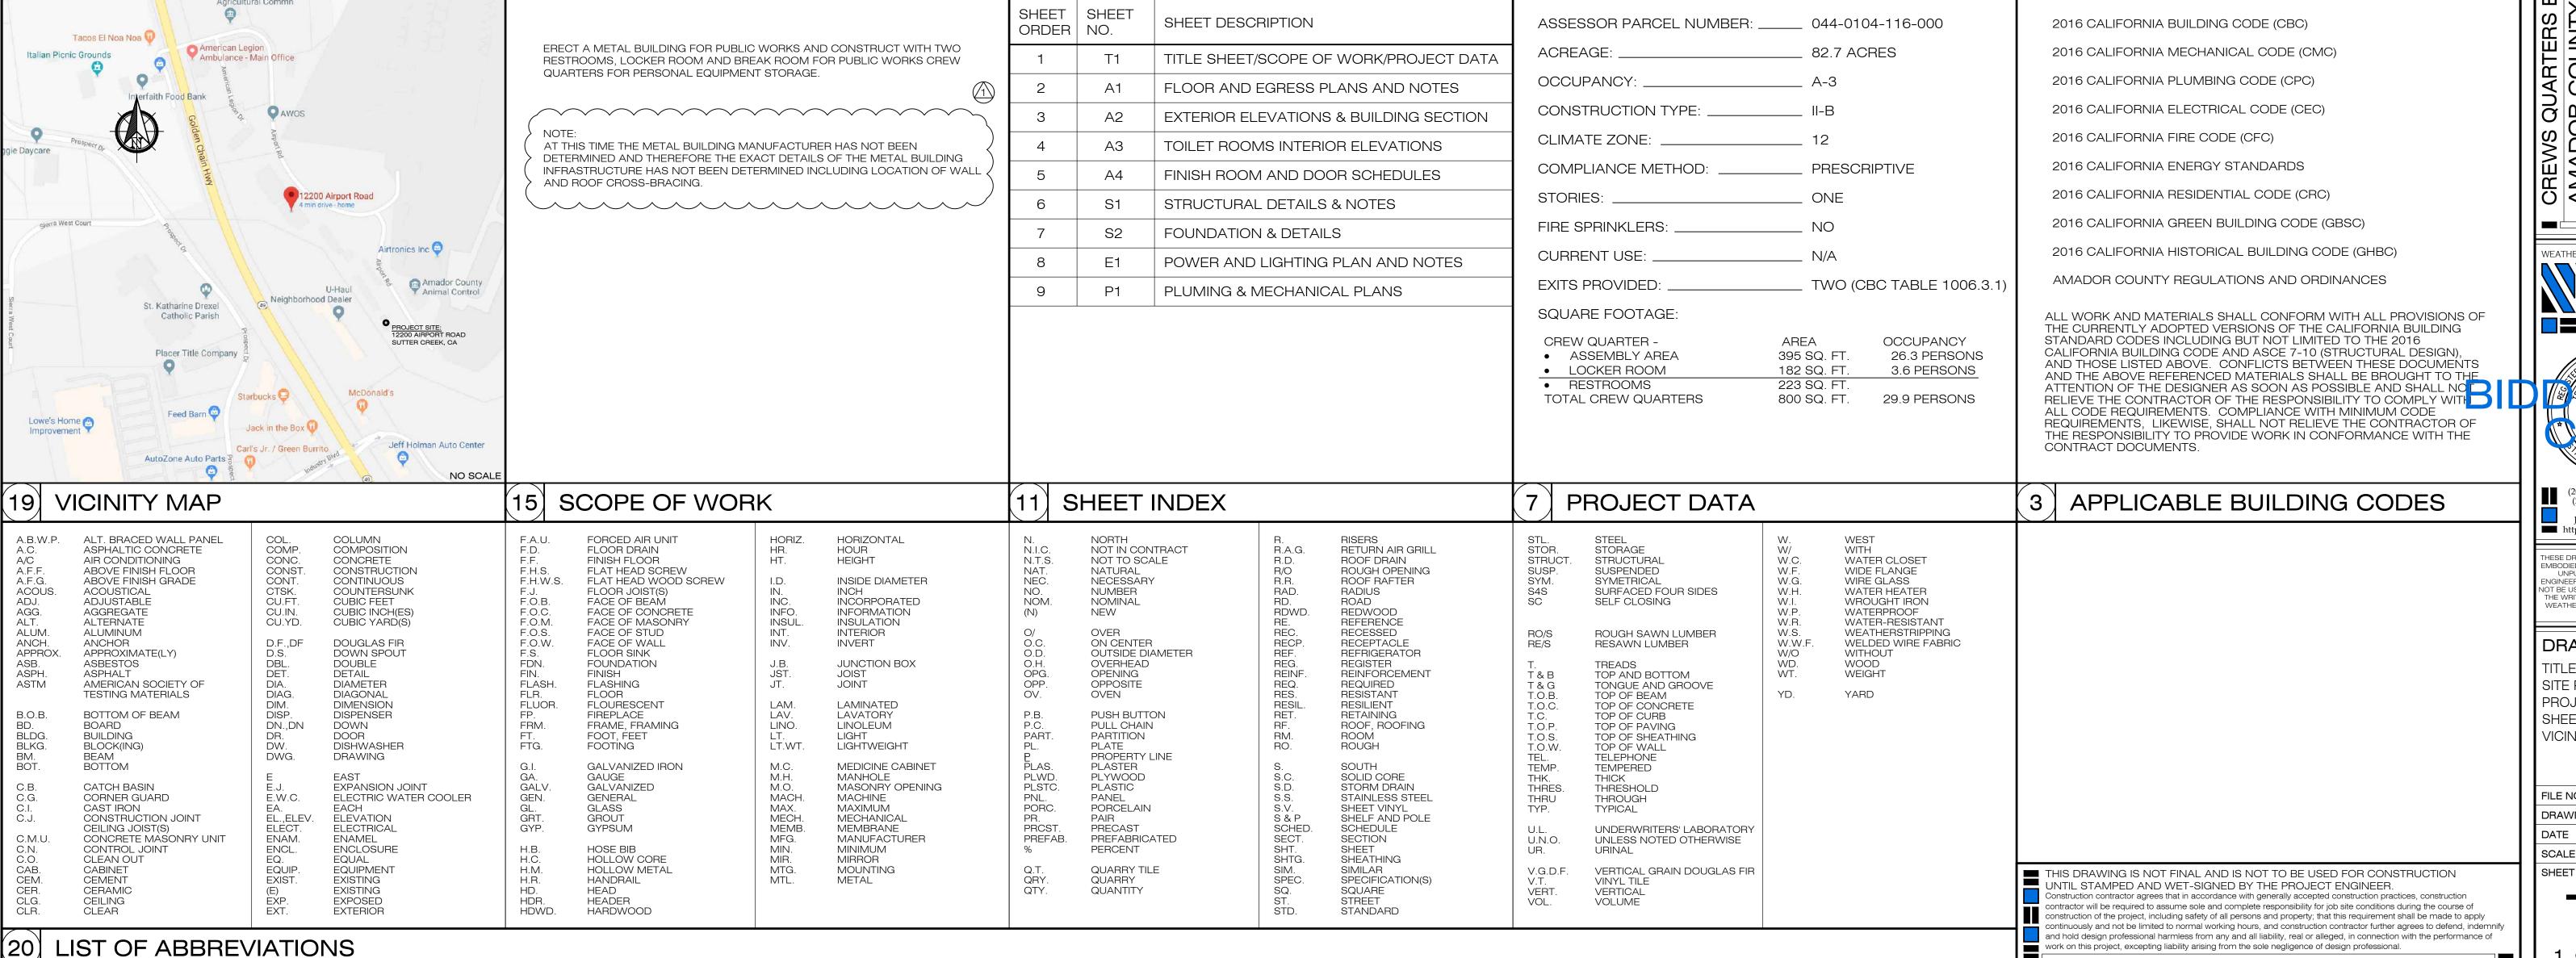

Jackson, CA. 95642

http://www.wrfed.com

THESE DRAWINGS AND THE CONCEP'
EMBODIED THEREIN ARE THE ORIGINA
UNPUBLISHED WORK OF WRF
ENGINEERING AND DESIGN AND SHAI
NOT BE USED OR DUPLICATED WITHO
THE WRITTEN AGREEMENT OF TERR
WEATHERBY, GRANT REYNOLDS, OF
KEVIN FRITSON

(209)-223-0716 [Fax] 206 Peek Street

DRAWINGS TITLE SHEET-SITE PLAN-PROJECT DATA-SHEET INDEX-VICINITY MAP


FILE NO. D-7467


DRAWN BY VLM


DATE 01-2019


SCALE AS NOTED


1 OF 9 SHEETS

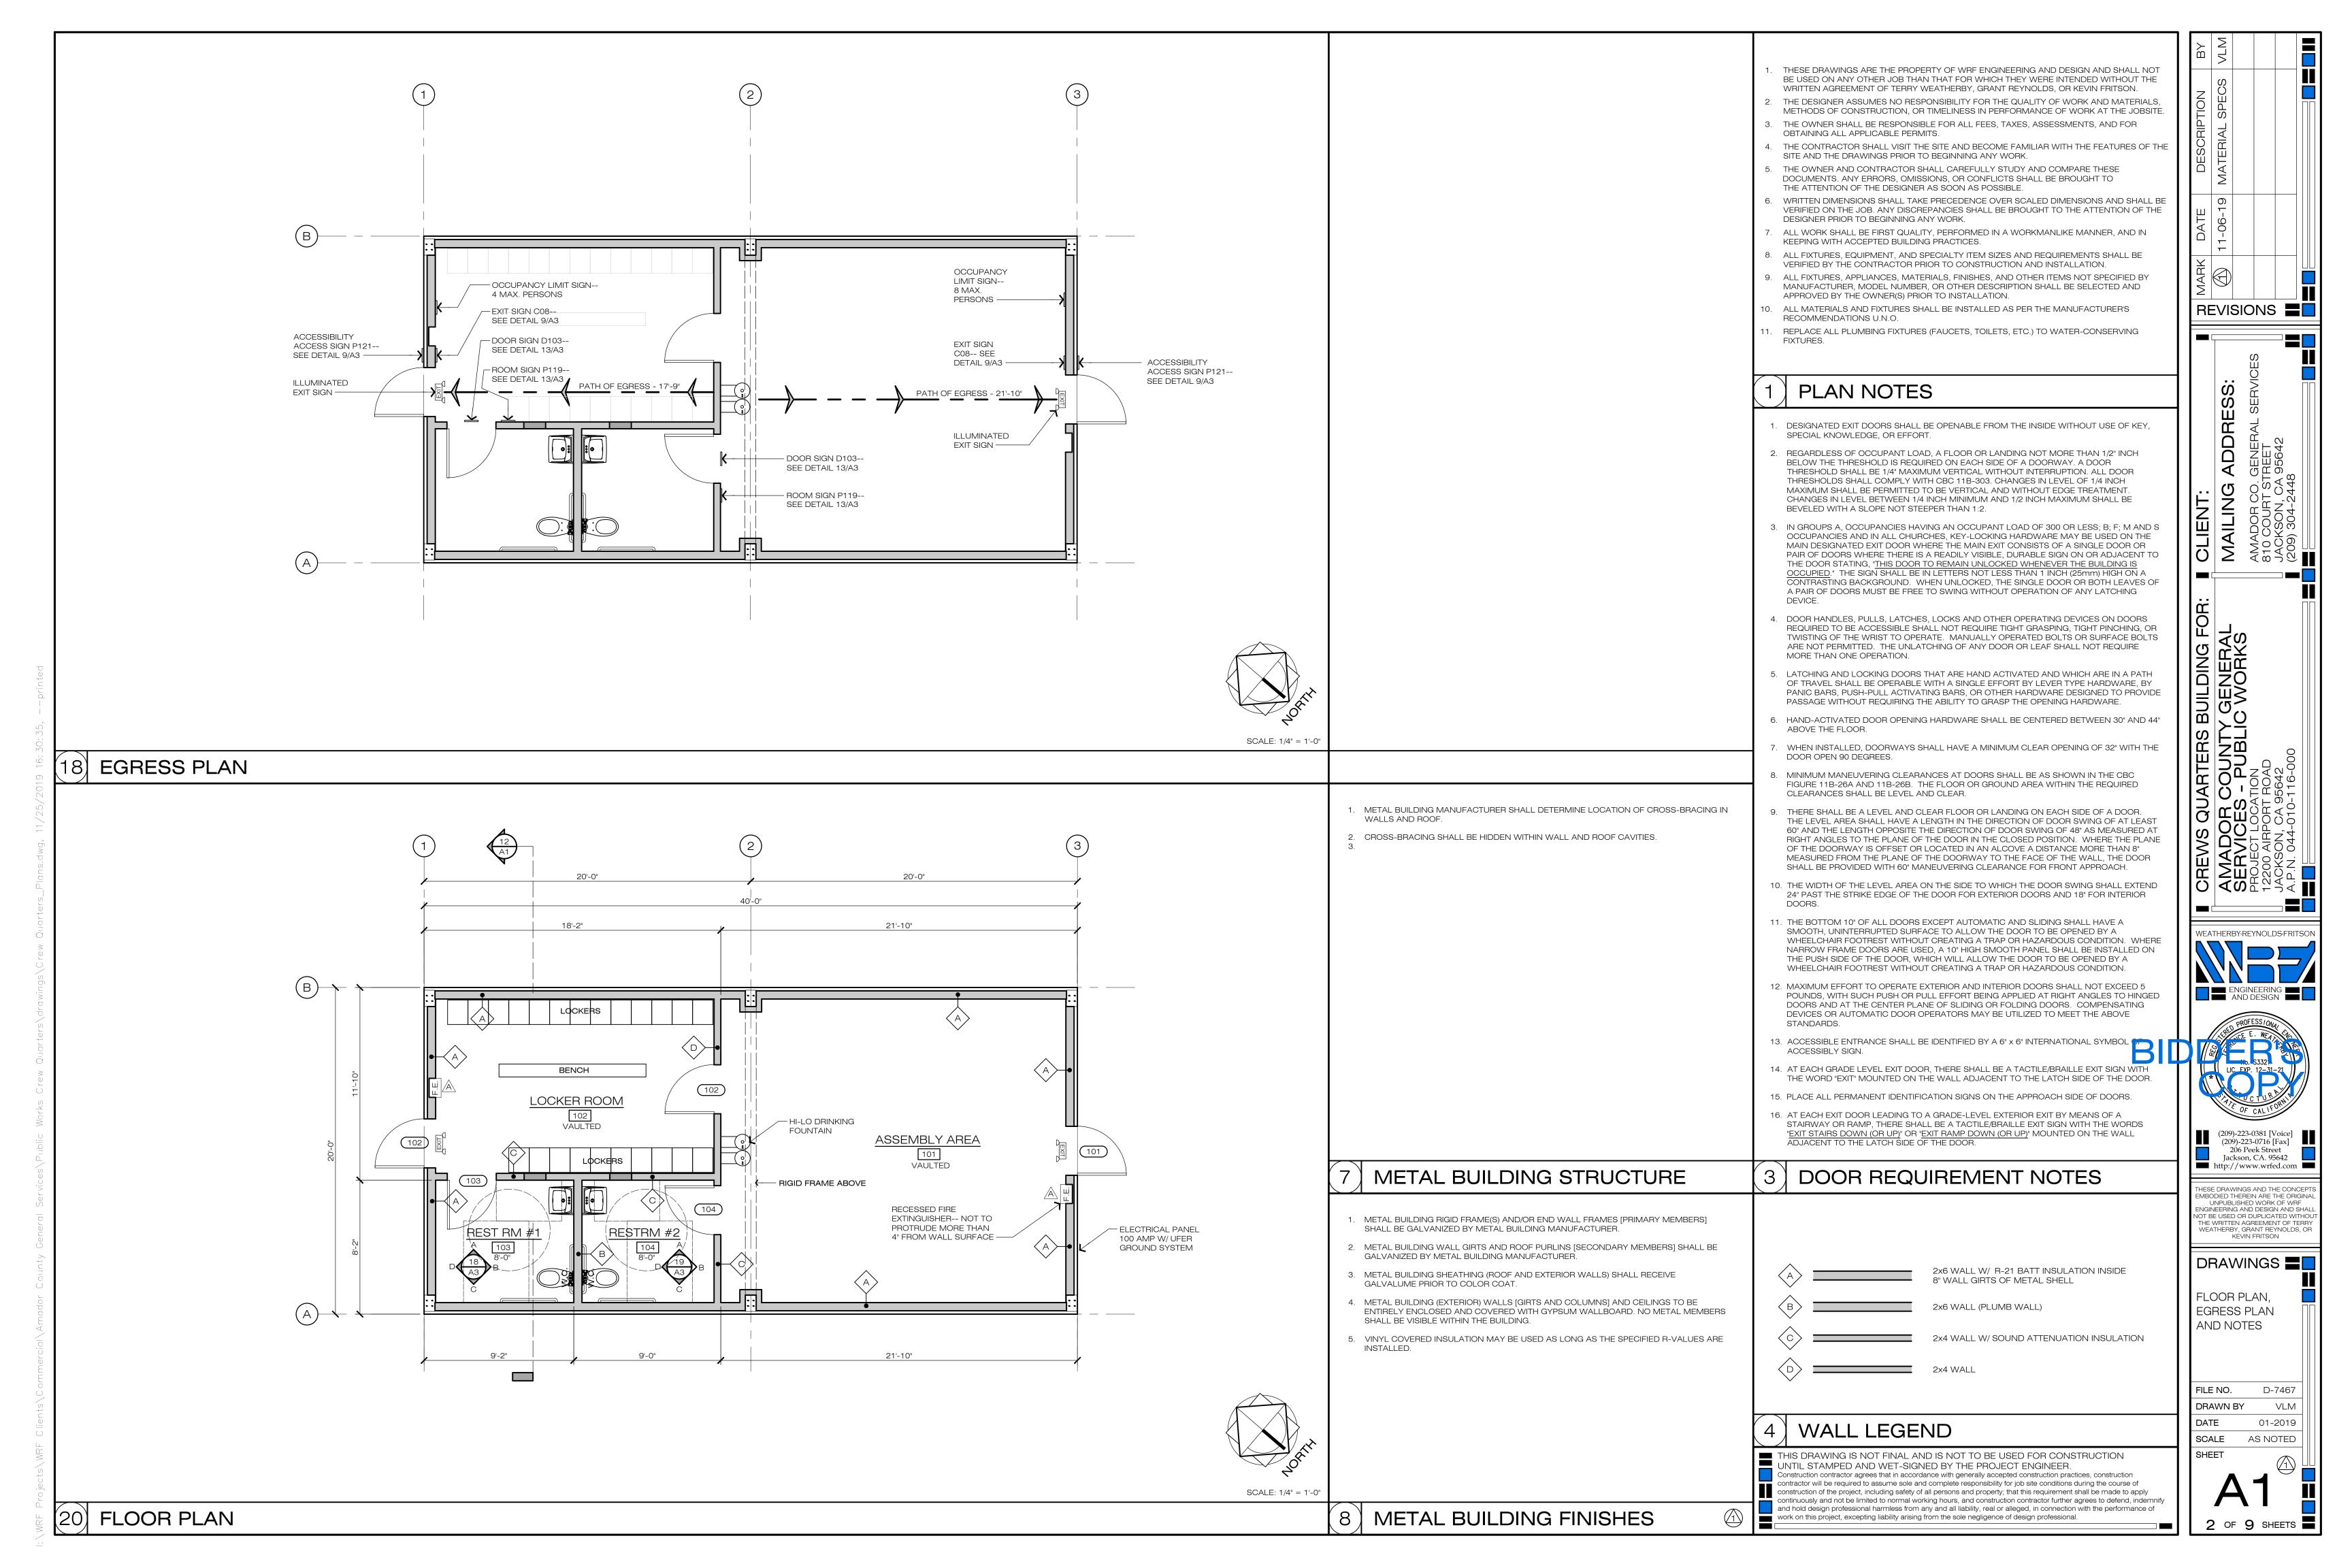

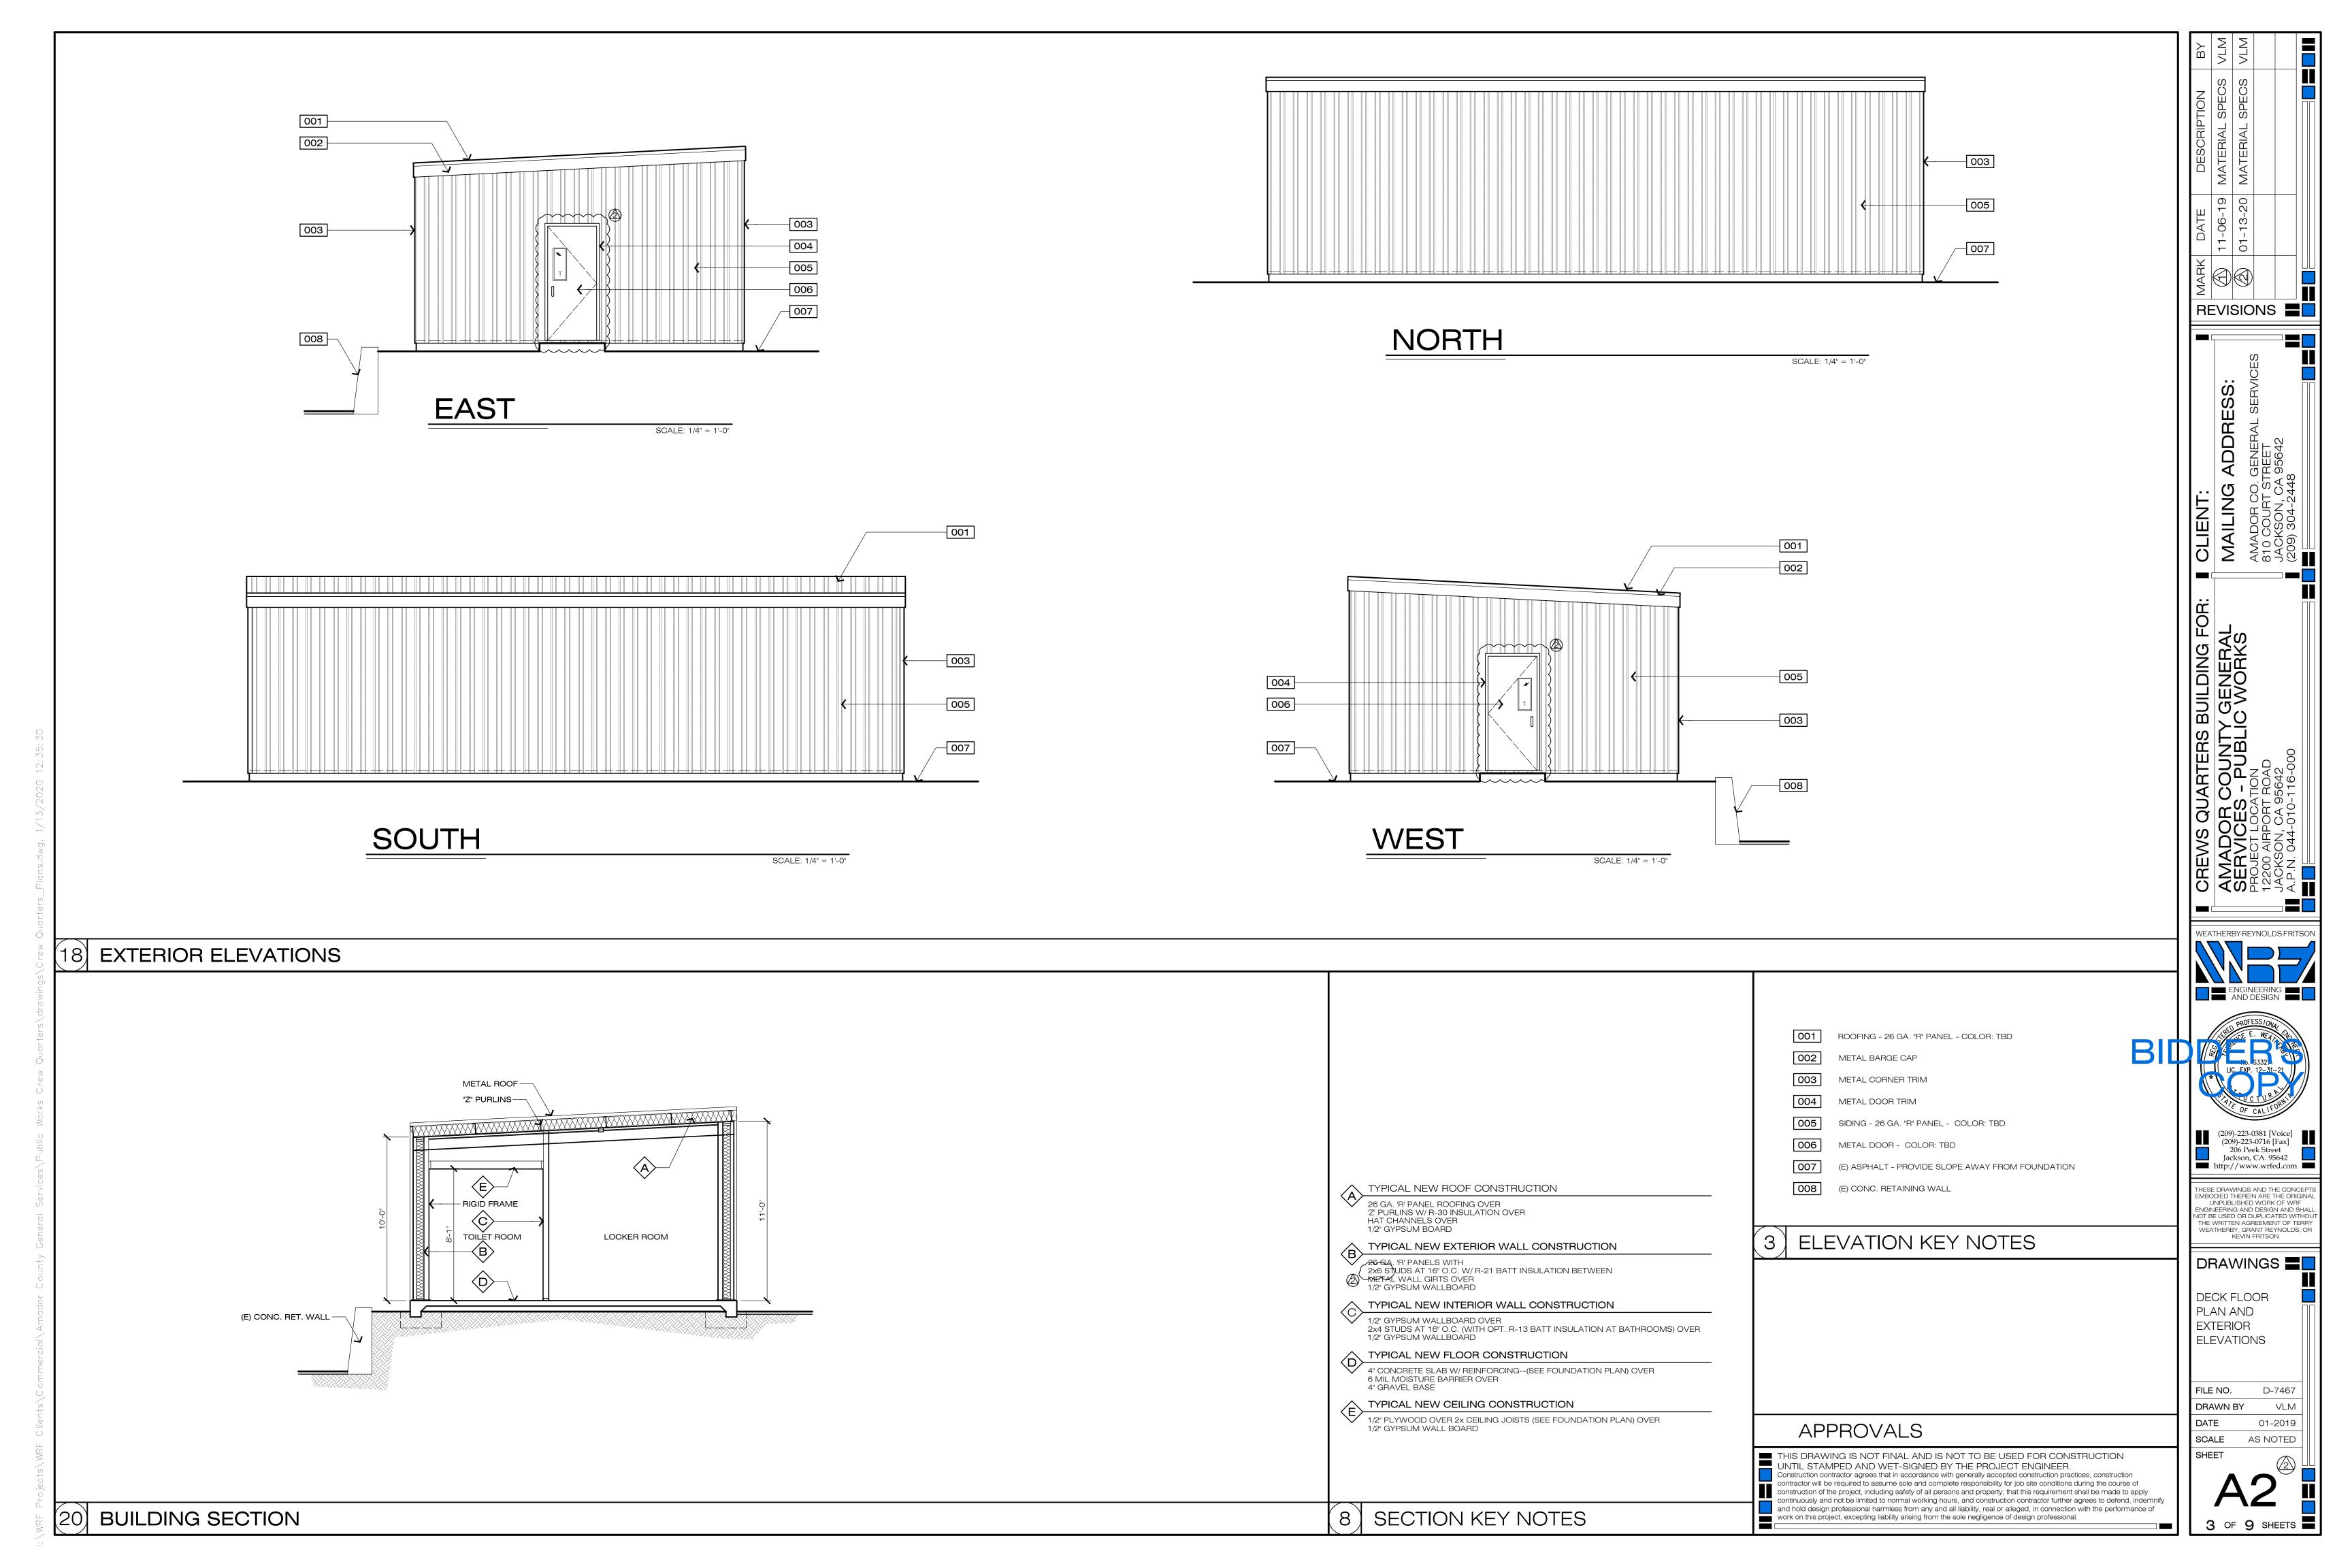

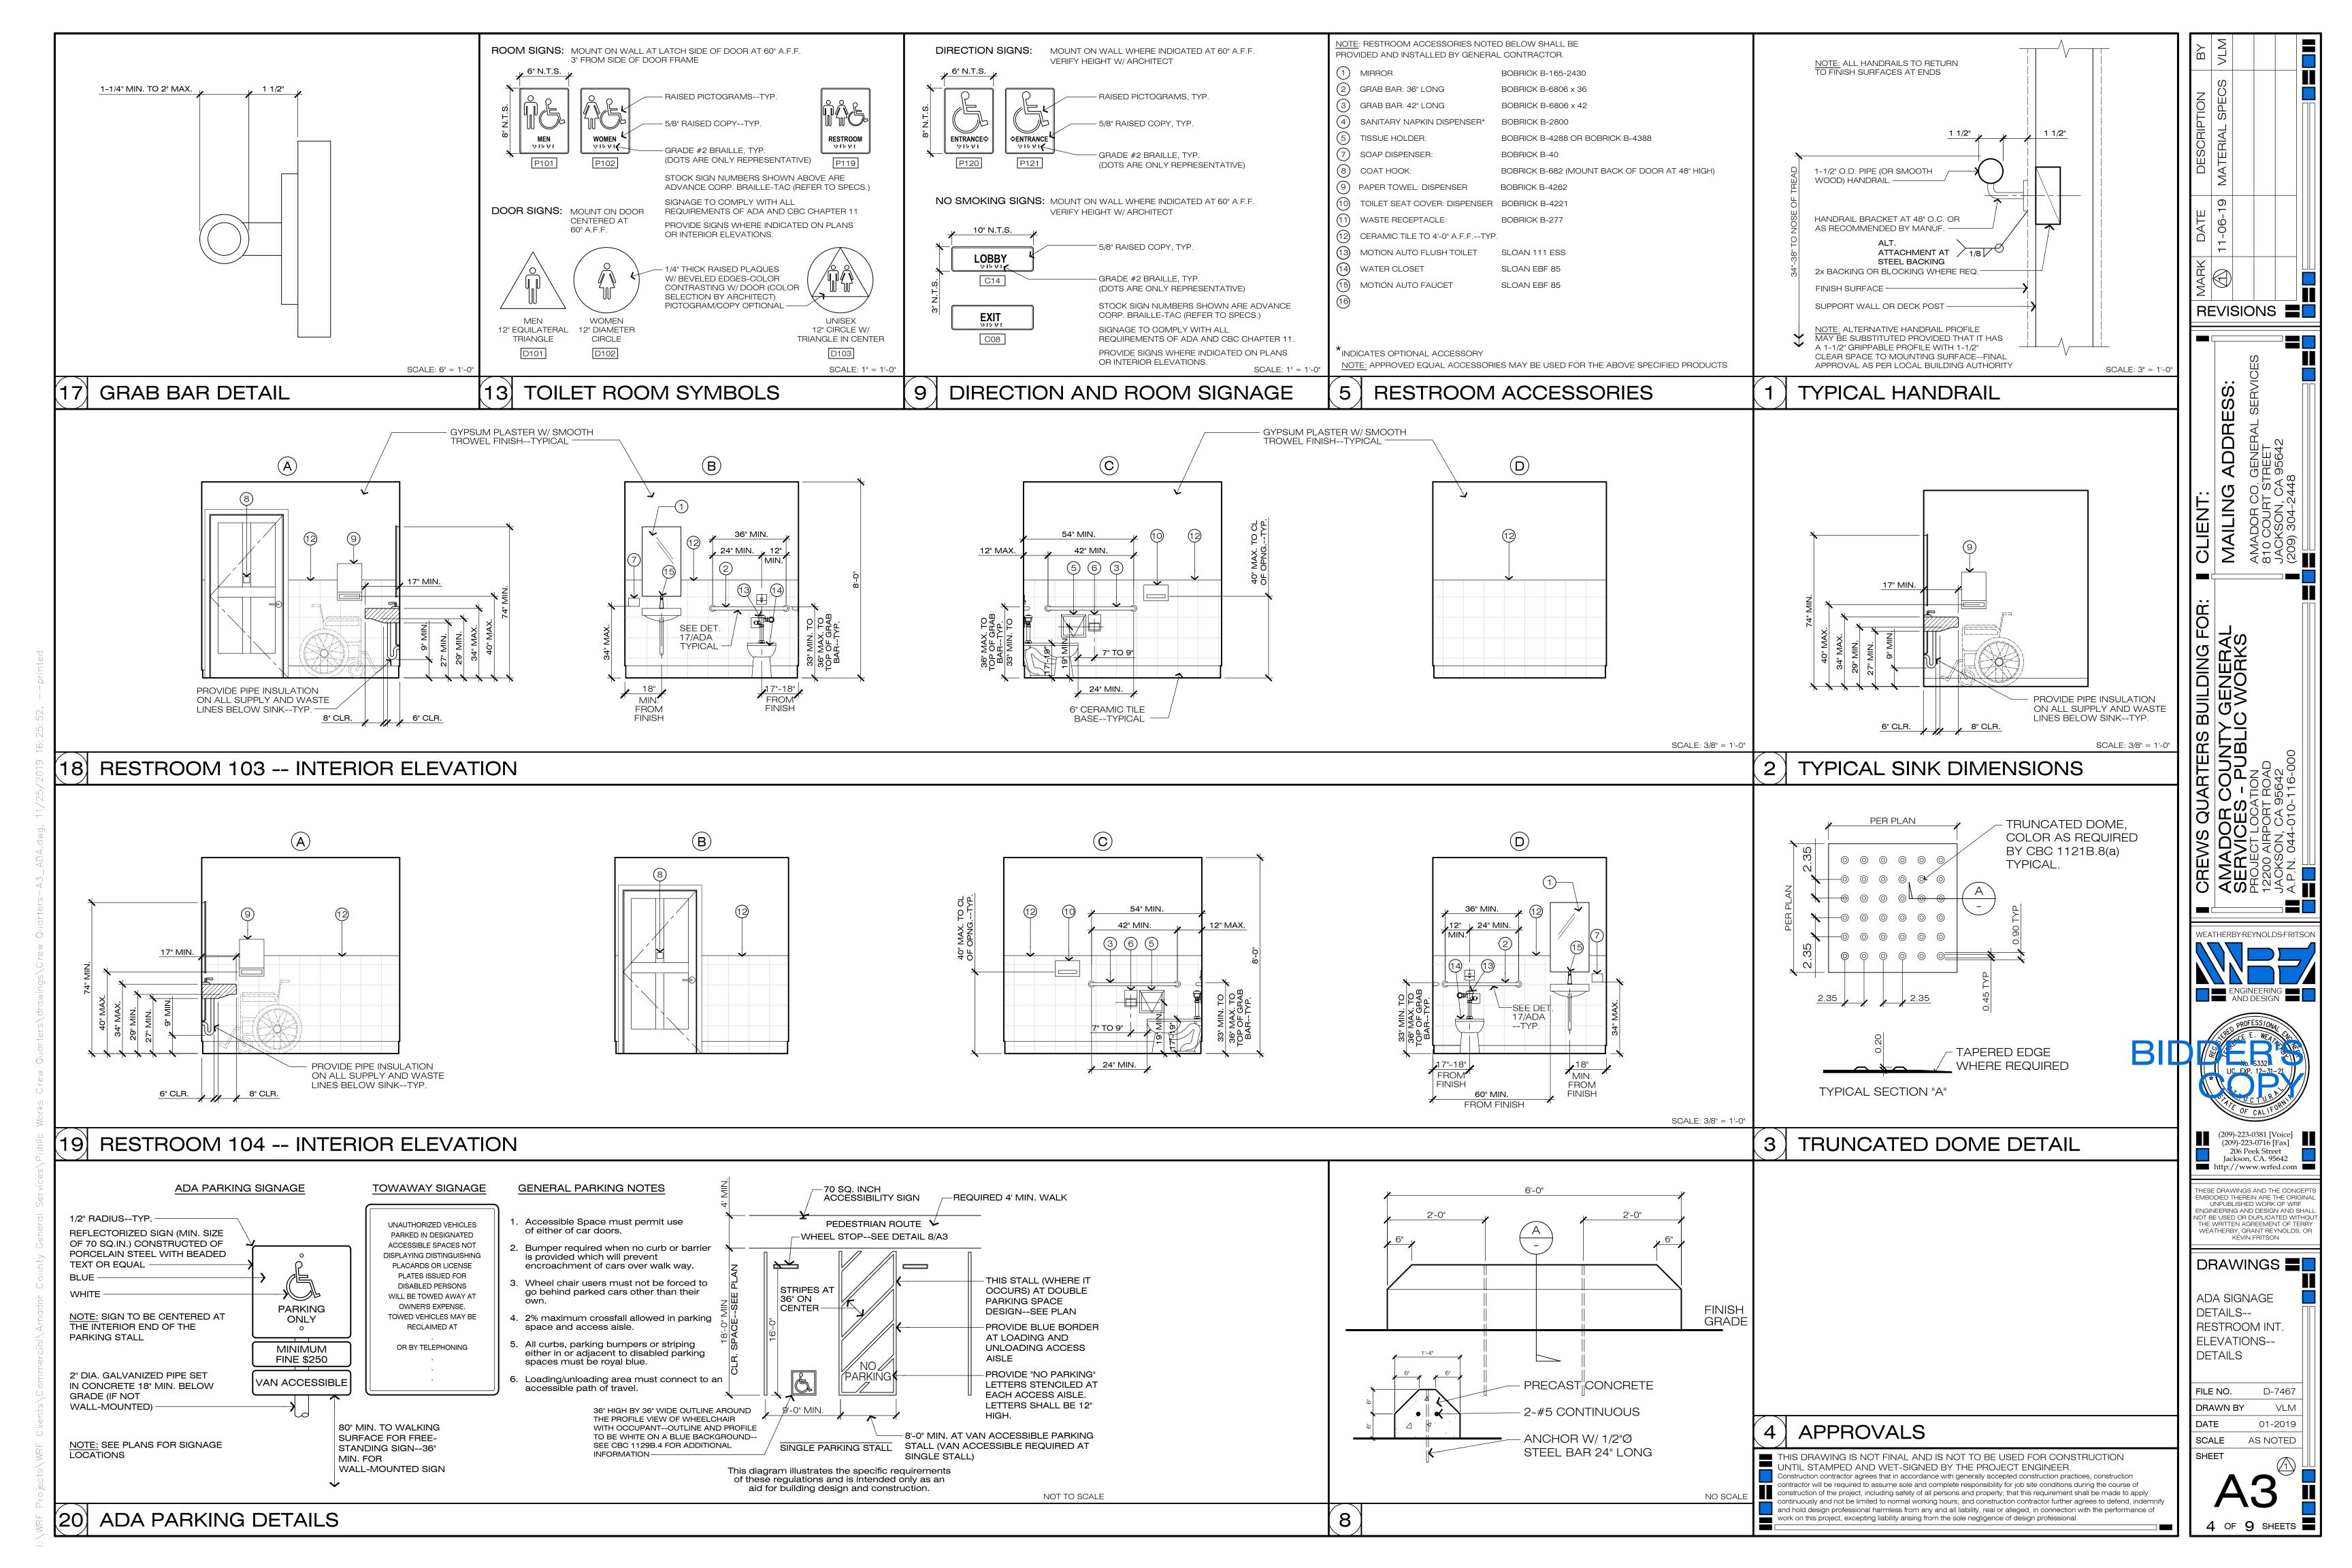

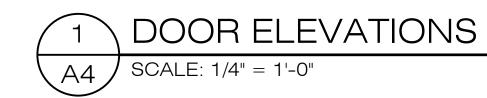

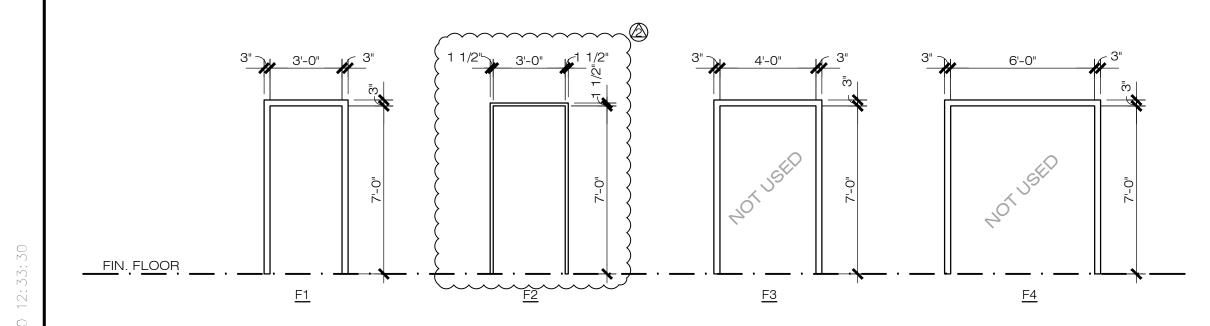

## FRAME ELEVATIONS A4 SCALE: 1/4" = 1'-0"

### DOOR SCHEDULE

ROOM		DOOR					FRAME				DETAILS		FIRE		NOTES	
ROOM NAME	ROOM NO.	NO.	ELEV.	TYPE	HDW.	FINISH	ELEV.	TYPE	FINISH	HEAD JAMB SILL		RATING	SIGNAGE			
ASSEMBLY AREA	101	101	D1	SGM	DLH	FAPE	F1	MTL	FAPE	-	-	-	3/4 HR.	-	PANIC BAR INSIDE W/ CLOSER	
LOCKER ROOM	102	102	D1	SGM	DLH	FAPE	F1	MTL	FAPE	-	-	-	3/4 HR.	-	PANIC BAR INSIDE W/ CLOSER	
LOCKER ROOM	102	(102A)	D2	SGM	DLH	FAPE	F2	MTL	FAPE	-	-	-	-	-	(CLOSER)	
RESTROOM #1	103	103	D1	SGM	DLH	FAPE	F1	MTL	FAPE	-	-	-	-	-	CLOSER	
RESTROOM #2	104	104	D1	SGM	DLH	FAPE	F1	MTL	FAPE	-	-	-	-	-	CLOSER	

#### ABBREVIATIONS

CS

CL	CLEAR	GL	INSULATED DOUBLE GLAZING	SCM	INSULATED CORE METAL	GLS	GLASS
F	FROSTED GLASS	HCW	HOLLOW CORE WOOD	GLP	GLASS PLATED	DLH	DOOR LEVER - ADA COMPLIANT
FAPE	FIELD APPLIED PAINT, ENAMEL	SCW	SOLID CORE WOOD- 1 HR. FIRE	OPH	OFFSET PUSH/PULL HANDLES-ADA COMPLIANT	MTL	METAL FRAME

### FINISH SCHEDULE

ROOM NO.	ROOM NAME	FLOOR	BASE	WALLS							CEIL	LING	NOTES	
				NO	NORTH		EAST		SOUTH		WEST			
		MATERIAL	MATERIAL	MATERIAL	MATERIAL FINISH MA		FINISH	MATERIAL	ATERIAL FINISH		MATERIAL FINISH		FINISH	
101	ASSEMBLY AREA	CN	R	GWB	PE	GWB	PE	GWB	PE	GWB	PE	GWB	PE	-
102	LOCKER ROOM	CN	R	GWB	PE	GWB	PE	GWB	PE	GWB	PE	GWB	PE	-
103	RESTROOM #1	CT	CT	GWB	CT, PE	GWB	CT, PE	GWB	CT, PE	GWB	CT, PE	GWB	PE	-
104	RESTROOM #2	СТ	СТ	GWB	CT, PE	GWB	CT, PE	GWB	CT, PE	GWB	CT, PE	GWB	PE	-

NOTES ABBREVIATIONS

SUSPENDED ACOUSTIC TILE (T-BAR)	GWB	GYPSUM WALL BOARD - 5/8" MIN.
CARPET & PAD	MR-GWB	MOISTURE RESISTANT GYPSUM WALL BOARD
CEMENT BACKER BOARD FOR CERAMIC TILE	PE	PAINT, ENAMEL
POLISHED CONCRETE	R	RESILIENT RUBBER
RESIN COATED CONCRETE	TX	TEXTURED GYPSUM BOARD
CONCRETE WITH PENETRATING SEALER	MV	MEDICAL GRADE VINYL
CERAMIC TILE	WD	WOOD
GLASS		

OPENING SIZE-- SIZES INDICATED ARE ACTUAL DOOR (OR COMBINATION OF DOORS) SIZES IN FEET AND INCHES U.N.O.--VERIFY ALL ROUGH OPENING SIZES

2. ALL DOORS U.N.O. TO BE PROVIDED WITH LEVER-TYPE HARDWARE APPROVED FOR HANDICAPPED ACCESSIBILITY.

MAIN EXIT DOOR (DOOR TYPE "1") TO BE EQUIPPED WITH KEY LOCKING HARDWARE (INSIDE AND OUT). PROVIDE A READILY VISIBLE, DURABLE SIGN ON OR ADJACENT TO THE DOOR STATING, "THIS DOOR MUST REMAIN UNLOCKED DURING BUSINESS HOURS." THE SIGN SHALL BE IN LETTER NOT LESS THAN 1" HIGH ON A CONTRASTING BACKGROUND. WHEN UNLOCKED, THIS MAIN EXIT MUST BE FREE TO SWING WITHOUT OPERATION OF ANY

4. MAXIMUM DOOR OPENING EFFORT OF 5 LBS OR LESS AT ALL DOORS UNLESS AT A FIRE RATED DOOR THEN PROVIDE MAXIMUM DOOR OPENING EFFORT OF 15LBS OR LESS.

5. PROVIDE 10" HIGH KICK PLATES AT BOTTOM OF ENTRY-DOORS PER CBC SECTION 1133B.2.6.

6. ALL DOORS TO HAVE A MAXIMUM 1/2" THRESHOLD (ABOVE FLOOR AND LANDING ON BOTH SIDES) PER CBC 1003.3.1.6 AND 1133B.2.4.1.

## DOOR NOTES

THIS DRAWING IS NOT FINAL AND IS NOT TO BE USED FOR CONSTRUCTION UNTIL STAMPED AND WET-SIGNED BY THE PROJECT ENGINEER. Construction contractor agrees that in accordance with generally accepted construction practices, construction contractor will be required to assume sole and complete responsibility for job site conditions during the course of construction of the project, including safety of all persons and property; that this requirement shall be made to apply continuously and not be limited to normal working hours, and construction contractor further agrees to defend, indemnify and hold design professional harmless from any and all liability, real or alleged, in connection with the performance of work on this project, excepting liability arising from the sole negligence of design professional.

REVISIONS



(209)-223-0381 [Voice] (209)-223-0716 [Fax] (209)-223-0716 [Fax] 206 Peek Street Jackson, CA. 95642 http://www.wrfed.com

THESE DRAWINGS AND THE CONCEPTS EMBODIED THEREIN ARE THE ORIGINAL UNPUBLISHED WORK OF WRF ENGINEERING AND DESIGN AND SHALL


ENGINEEHING AND DESIGN AND SHAL NOT BE USED OR DUPLICATED WITHOL THE WRITTEN AGREEMENT OF TERRY WEATHERBY, GRANT REYNOLDS, OR KEVIN FRITSON DRAWINGS =


FINISH AND DOOR SCEDULES


> D-7467 FILE NO. DRAWN BY VLM 01-2019

SCALE AS NOTED



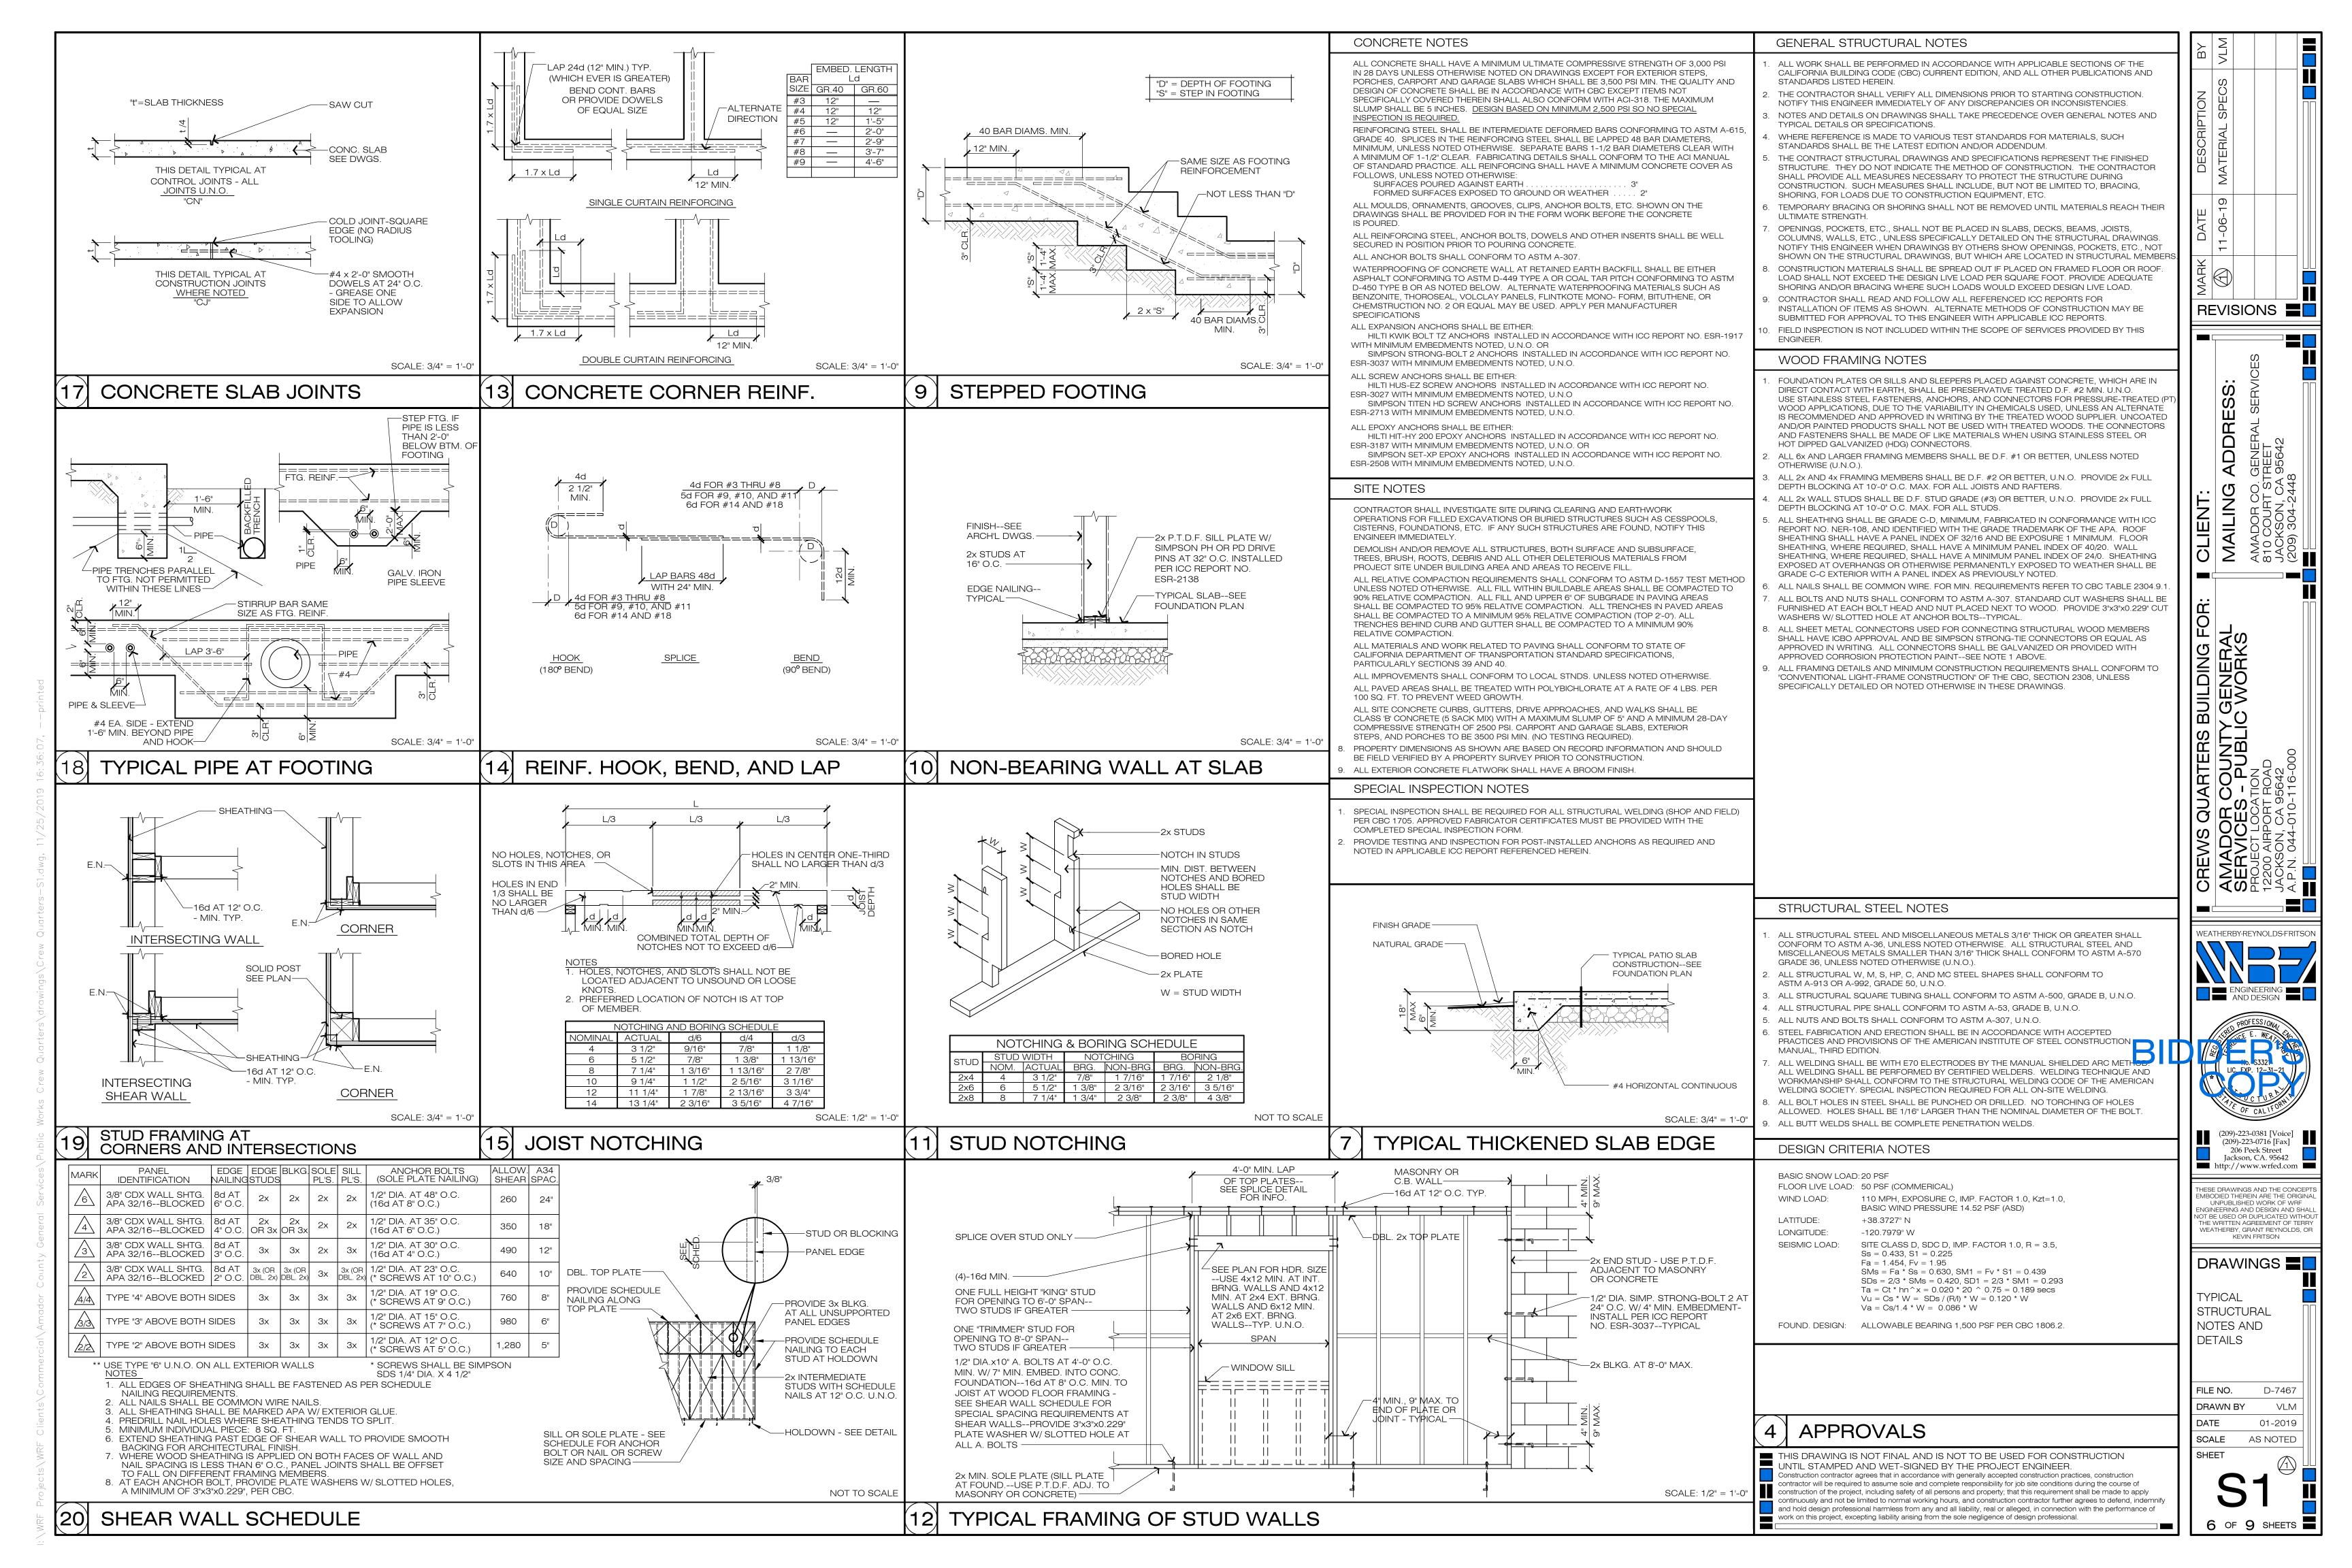

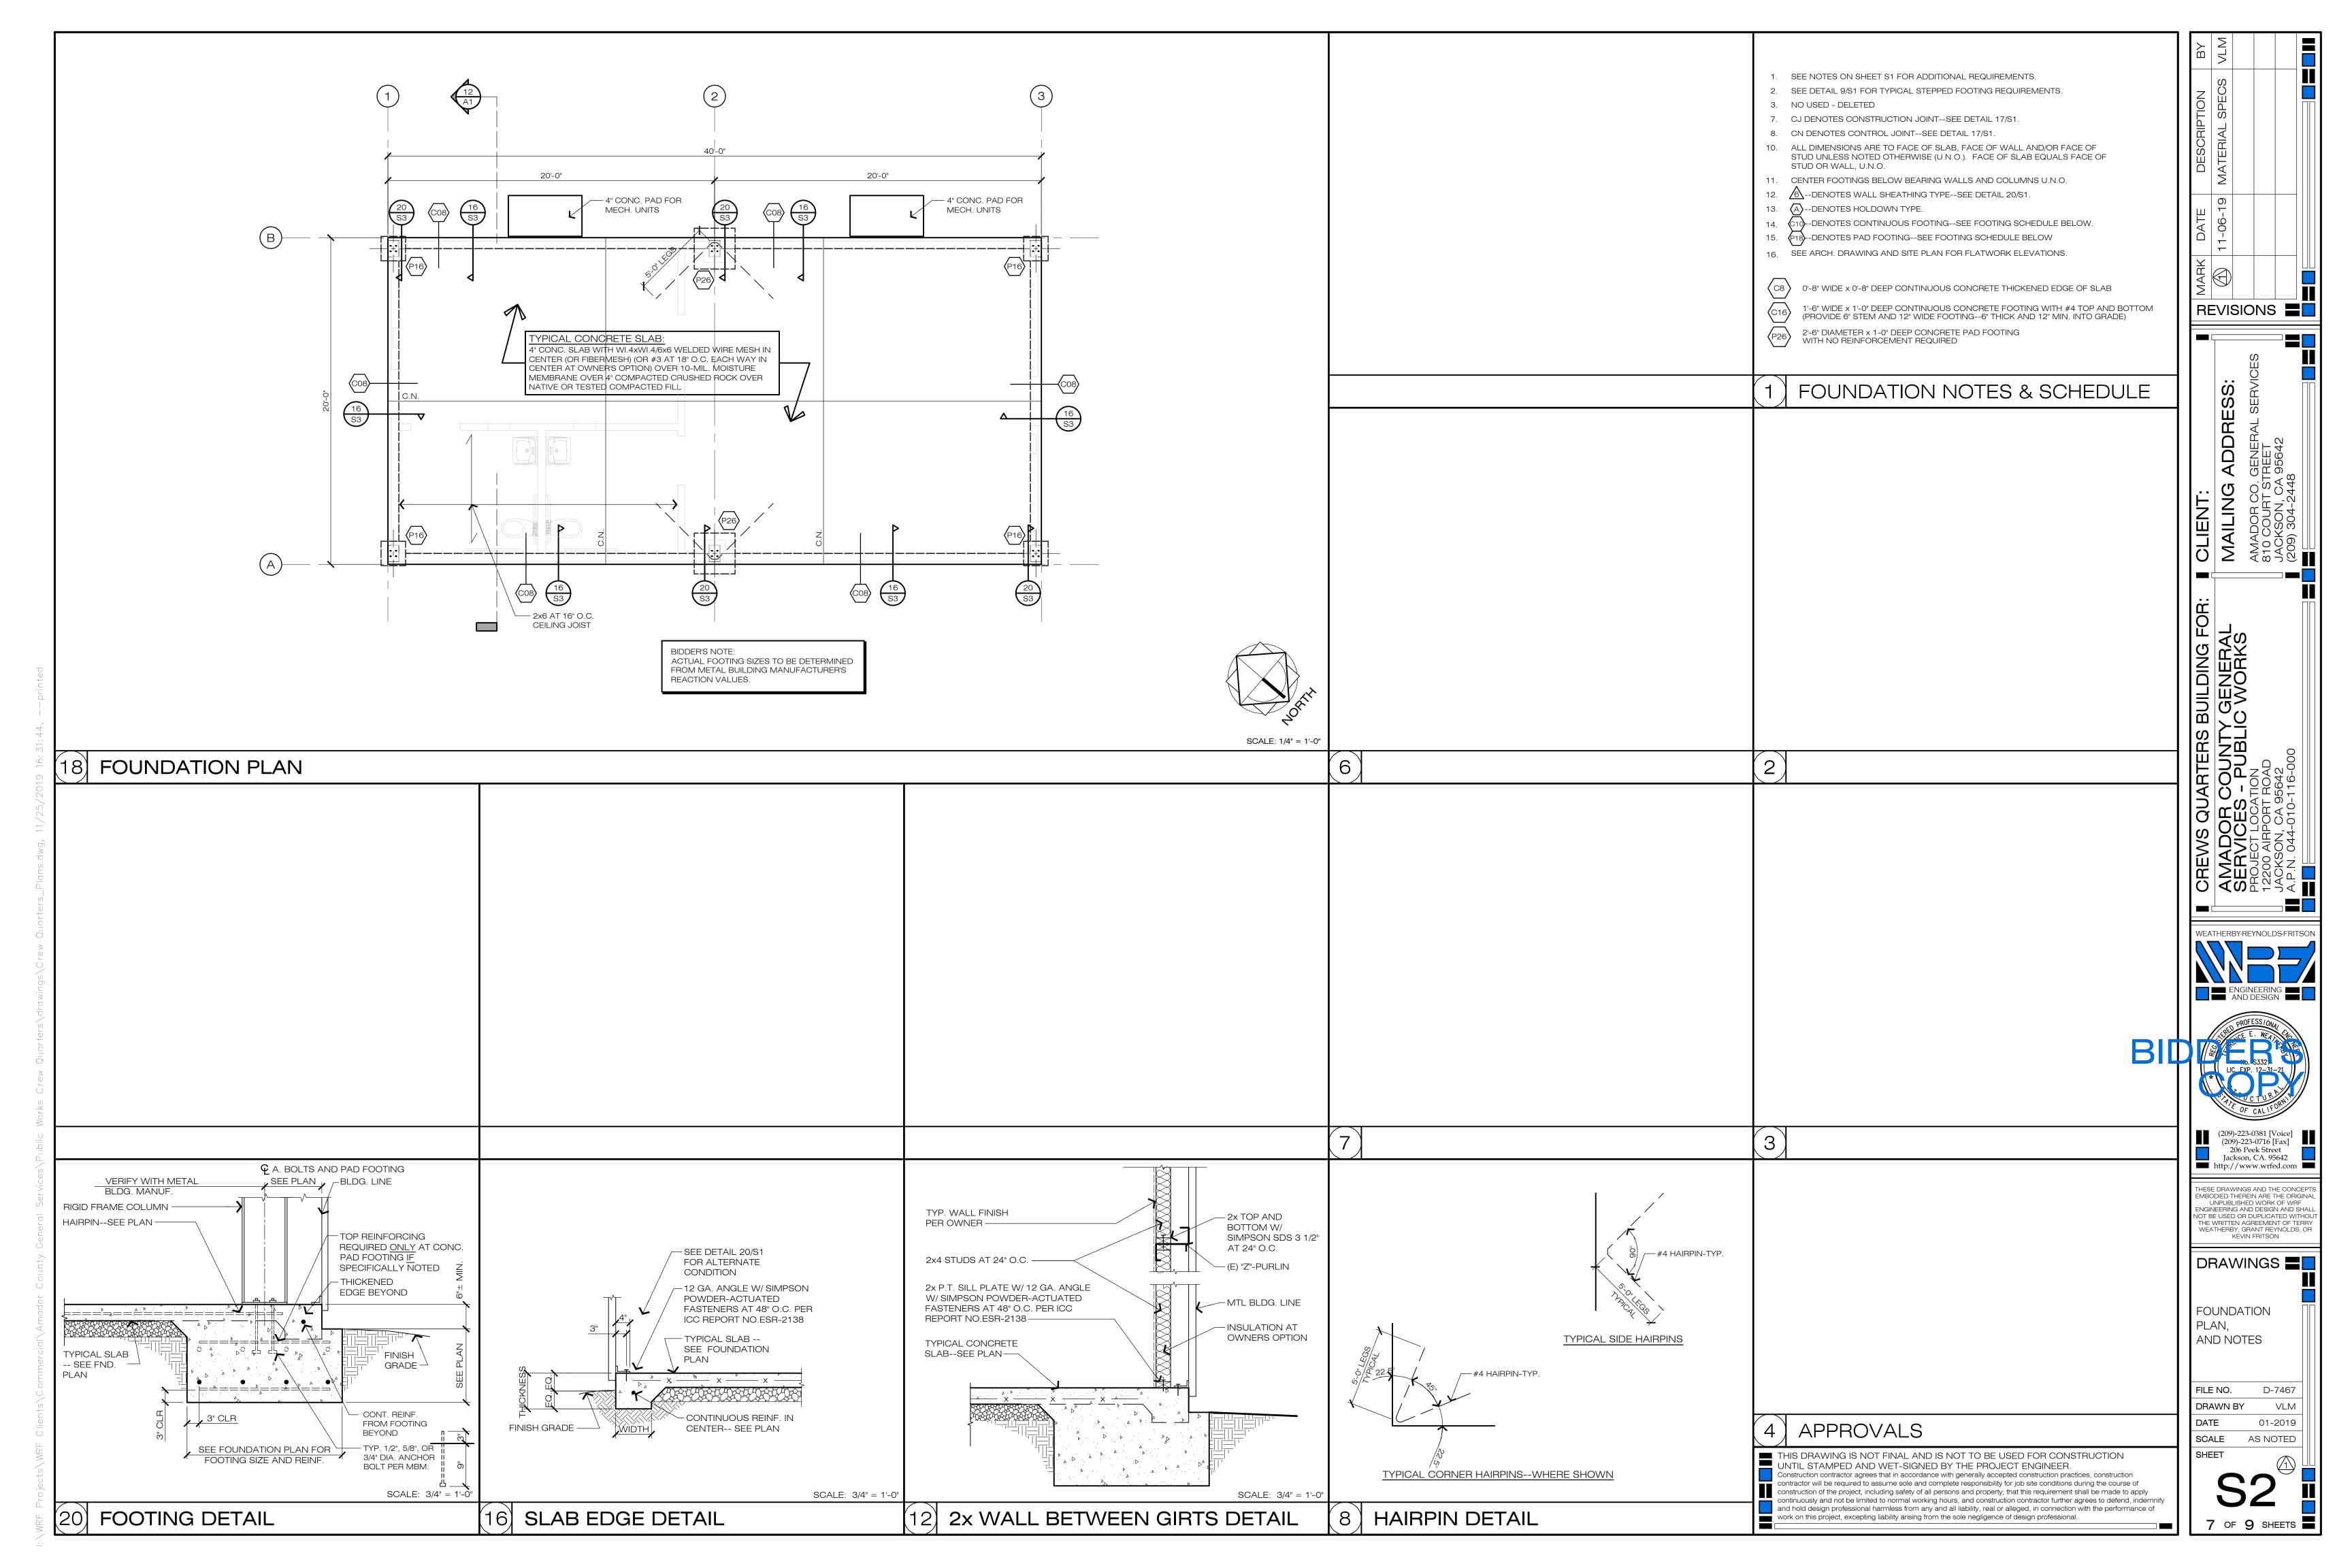

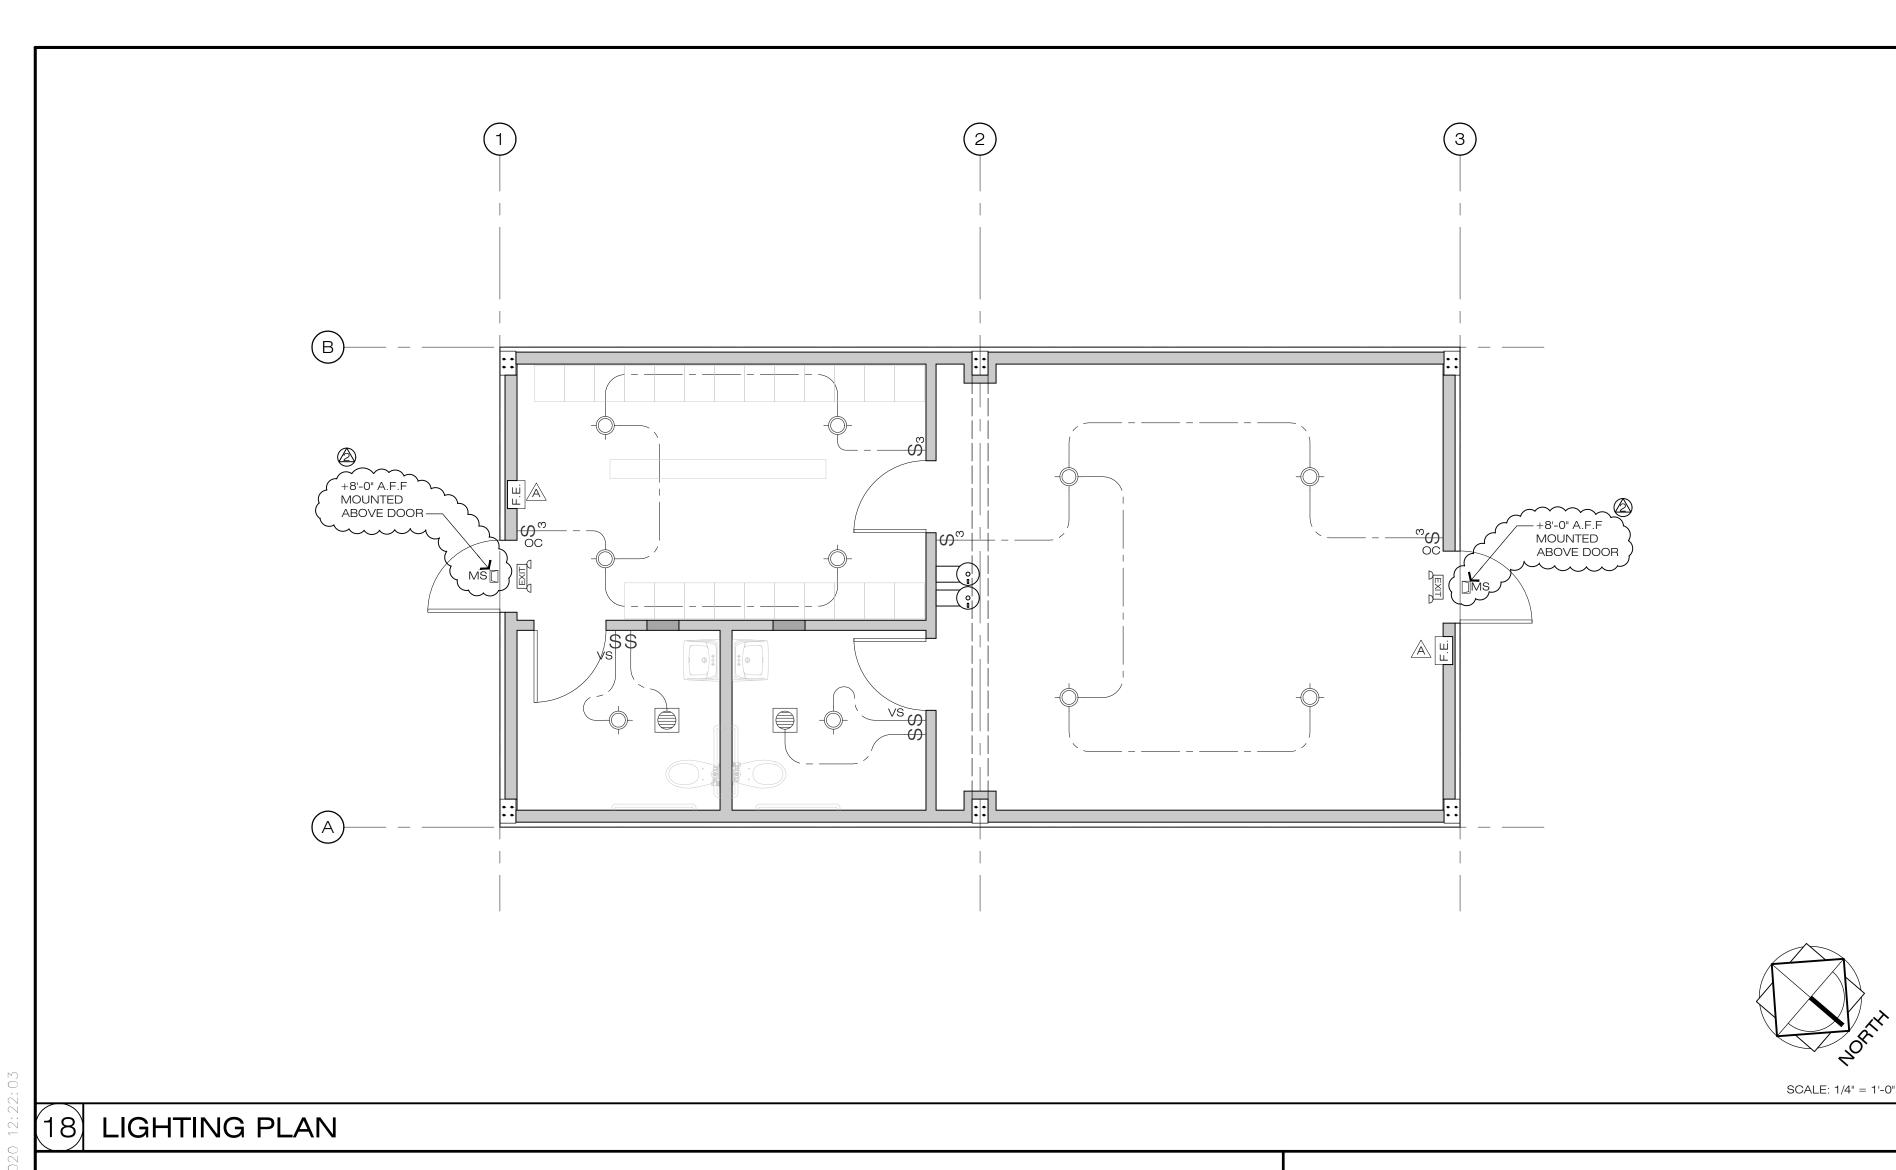

LIGHTING FIXTURE SCHEDULE													
SYM	NO.	TYPE	MANUFACTURE	QTY	WATT	LOCATION	COMMENTS						
	L1	LED CEILING	GEORGE KOVACS: P842	10	25	101, 102, 103 & 104	10" FLUSH MOUNT -2326 LUMENS						
	L2	WALL LIGHT	LITHONIA: WDGE1 LED	2 (	4	EXIT DOORS	WALL MOUNT -						

	ROOM LIGHTING SCHEDULE													
RM NO.	ROOM NAME	TYPE OF LIGHTING	QTY FIX	FOOT CANDLES	COMMENTS									
101	ASSEMBLY AREA	LED CEILING	4	23.5										
102	LOCKER ROOM	LED CEILING	4	51.1										
103	RESTROOM #1	LED CEILING	1	20.7										
104	RESTROOM #2	LED CEILING	1	20.7										

### LIGHT FIXTURE AND ROOM LIGHTING SCHEDULES

- ALL FIXTURES SHALL BE OWNER SELECTED AND APPROVED PRIOR TO INSTALLATION. 2. THE CONTRACTOR SHALL VERIFY THE LOCATION OF ALL FIXTURES, JACKS, AND RECEPTACLES WITH THE OWNER(S) PRIOR TO INSTALLATION. PROVIDE ADDITIONAL ITEMS NOT SHOWN IN THE DRAWINGS AS DIRECTED BY THE OWNER(S) AT A COST TO BE AGREED UPON PRIOR TO THE PERFORMANCE OF ANY WORK.
- 3. PROVIDE GFCI CIRCUITS FOR ALL BATH AND EXTERIOR. 4. PROVIDE (2)-SEPARATE 20-AMP CIRCUITS AT KITCHEN/BREAKFAST AREA WHICH SHALL NOT BE USED TO SUPPLY POWER TO LIGHT FIXTURES.
- 5. PROVIDE INDEPENDENT CIRCUITS SIZED AS REQUIRED FOR EACH OF THE FOLLOWING APPLIANCES WHERE THEY OCCUR: DRYER, WASHER, RANGE, OVENS, WATER HEATER. SWAMP COOLER, HVAC, FREEZER, MICROWAVE, AND COMPUTER. RANGES AND DRYERS REQUIRE A 4-WIRE GROUNDED RECEPTACLE OUTLET REGARDLESS OF WHERE THE CIRCUIT ORIGINATES.
- BACKUP. ALL SMOKE DETECTORS SHALL BE AUDIBLE IN ALL SLEEPING AREAS OF THE DWELLING UNIT.

6. SMOKE DETECTORS SHALL BE 110V, HARD-WIRED INTO ELECT. SYSTEM WITH BATTERY

- 7. CEILING FANS SHALL BE INDEPENDENTLY SUPPORTED EXCEPT WHERE BOX IS SPECIFICALLY DESIGNED TO SUPPORT FAN.
- 8. CAULK AROUND ALL ELECTRICAL OUTLETS PENETRATING EXTERIOR SIDING. 9. ALL ELECTRICAL MATERIALS AND METHODS OF INSTALLATION SHALL BE IN CONFORMANCE WITH THE CURRENT ELECTRICAL CODES AS ADOPTED BY THE LOCAL
- 10. BATHROOM EXHAUST FANS TO BE CAPABLE OF OF PROVIDING A MINIMUM OF 5 AIR CHANGES PER HOUR (50 CFM) --VENT TERMINATION TO BE A MIN. OF 3' FROM ANY 11. ALL CONDUITS, UTILITIES, AND SERVICES, SHALL BE INSTALLED AS PER THE LOCAL

GOVERNING CODES, AND SHALL CONFORM TO THE REQUIREMENTS OF THE PROVIDING


SERVICE AND/OR UTILITY COMPANY. 12. ALL PHONE WIRING TO BE 3-PAIR MINIMUM TO ALL JACKS. 3. PROVIDE ALL WIRING, CONDUITS, BREAKERS, AND CONNECTIONS AS REQUIRED TO TIE-IN FUTURE PHOTOVOLTAIC POWER SYSTEM (WHERE IT OCCURS). ALL DETAILS TO BE WORKED OUT AND AGREED UPON BETWEEN CONTRACTOR AND OWNER PRIOR TO 14. PROVIDE AT LEAST ONE 20-AMP BRANCH CIRCUIT FOR BATHROOM OUTLETS WITH NO ADDITIONAL OUTLETS CONNECTED PER 2016 CEC SECTION 210.11C(3). 15. IN BATHROOMS, GARAGES, LAUNDRY ROOMS AND UTILITY ROOMS, AT LEAST ONE


LUMINARIE IN EACH OF THESE SPACES SHALL BE CONTROLLED BY A VACANCY SENOR.

- 16. ALL RECESSED LIGHT FIXTURES INTO CEILINGS SHALL MEET ALL THE FOLLOWING PER CBEES 150.0(K)1C: LISTED FOR ZERO CLEARANCE INSULATION, LABELED THAT CERTIFIED THE LUMINARIE IS AIRTIGHT WITH A LEAKAGE LESS THAN 2.0CFM AT 75 PASCALS, SEALED WITH A GASKET OR CAULK, ALLOW REPLACEMENT AND MAINTENANCE TO BE READILY ACCESSIBLE FOR BELOW THE CEILING WITHOUT CUTTING HOLES IN THE CEILING, SHALL NOT CONTAIN SCREWS BASE SOCKETS; AND
- SHALL CONTAIN LIGHT SOURCES THAT COMPLY WITH JA8. 17. ALL 125-VOLT, 15-AMP AND 20-AMP RECEPTACLES SHALL BE LISTED TAMPER RESISTANT
- 18. ALL OUTDOOR LIGHTING ATTACHED TO THE BUILDING SHALL BE CONTROLLED BY A MANUAL ON AND OFF SWITCH THE DOES NOT OVERRDIDE ON AND ONE OF THE FOLLOWING: CONTROLLED BY PHOTOCELL AND MOTION SENSOR, PHOTO CONTROL AND AUTOMATIC SWITCH CONTROL, ASTRONOMICAL TIME CLOCK, OR ENERGY MANAGEMENT CONTROL SYSTEM. 150(K)3
- 19. ALL LUMINAIRES REQUIRED TO HAVE LIGHT SOURCES COMPLIANT WITH CBEES TABLE 150.0-A AND REFERENCE JOINT APPENDIX JA8, EXCEPT HALLWAYS AND CLOSETS OVER 70 SF, SHALL BE CONTROLLED BY DIMMERS OR VACANCY SENSORS.
- 20. AN INTERSYSTEM BONDING ELECTRODE WHICH INCLUDES PROVISIONS FOR CONNECTING AT LEAST THREE GROUNDING OR BONDING CONDUCTORS REQUIRED FOR COMMUNICATIONS SYSTEMS SHALL BE INSTALLED EXTERNALLY AT THE SERVICE ENTRANCE PANEL AS SPECIFIED IN CEC 800.100(B) AND CEC 250.94.
- 21. EGRESS ILLUMINATION. PROVIDE EMERGENCY POWER OUTAGE ILLUMINATION TO THE FOLLOWING AREAS: AISLES, EGRESS CORRIDORS AND EXTERIOR EGRESS DISCHARGE LOCATIONS (I.E. EXTERIOR DOORS). 22. PROVIDE A MINIMUM OF 1 FOOT-CANDLE EMERGENCY EGRESS LIGHTING ALONG
- ENTIRE EXIST/EGRESS PATHWAY. CBC 1008.2.1. 23. PROVIDE OCCUPANT SENSING CONTROL AT ALL INTERIOR LIGHTING.



COMMENCING ANY CONCRETE WORK.

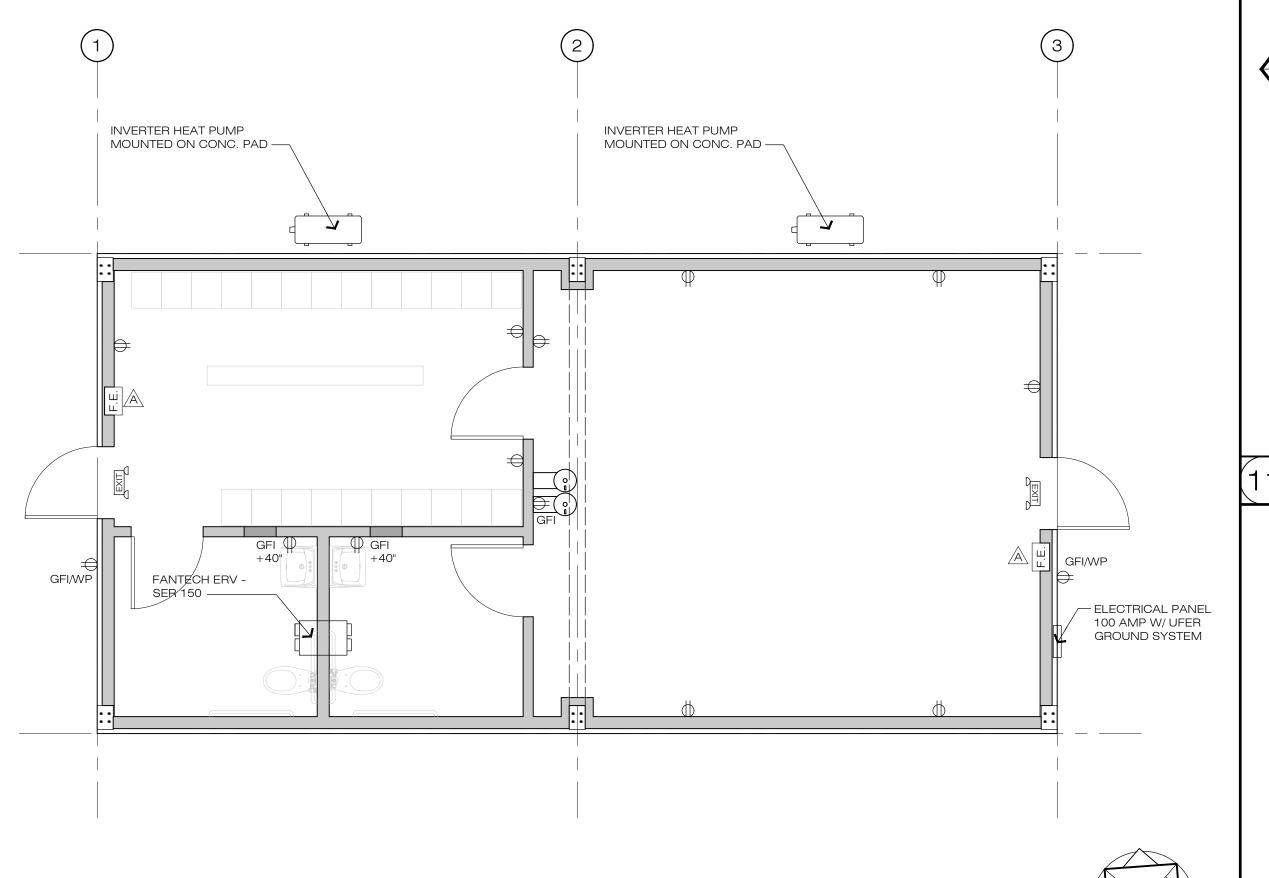

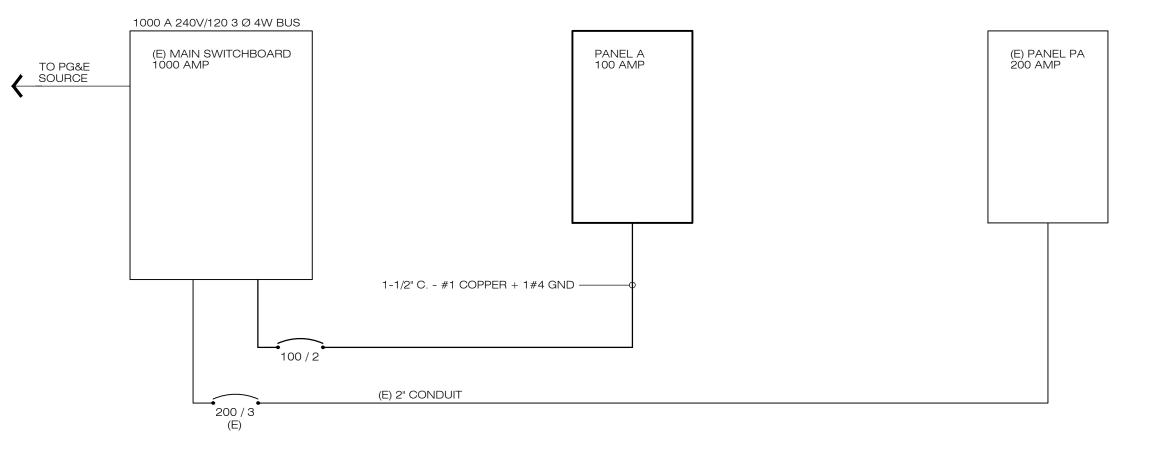

5" RECESSED CAN LIGHT W/ LED (NUMBER INDICATES HEIGHT FROM 220-V OUTLET **CEILING FAN** 1/2-SWITCHED OUTLET 110-V DUPLEX OUTLET ON — INDICATES LIGHT KIT (LED GROUND FAULT INTERRUPT CIRCUIT OR COMPACT FLOUR.) SURFACE-MOUNTED INCANDESCENT CEILING DEDICATED CIRCUIT OUTLET WALL SWITCH--(D) DENOTES DIMMER SUSPENDED LED PENDANT LAMP OR LIGHT CABLE PENDANT--SEE 3-WAY OR 4-WAY WALL SWITCH B HOSE BIBB (FP) DENOTES FREEZE-PROTECTION TYPE EXHAUST FAN W/ HUMIDITY LED WALL-MOUNT UPLIGHT EXHAUST FAN/LIGHT COMBO W/ HUMIDITY SENSOR WALL-MOUNTED COMPACT FLOUR. OR LED FIXTURE TRACK LIGHTING STRIP (SA INDICATES SWING-ARM) UNDERCOUNTER FLOURESCENT LED WALL PAK W/ PHOTOCELL \_\_\_\_\_ COMBINATION SMOKE AND CARBON MONOXIDE ALARM TELEPHONE JACK TV CO-AXIAL CABLE / SAT. JACK 2-TUBE FLOURESCENT SURFACE-MOUNT LIGHT GAS STUB THERMOSTAT EXTERIOR FLOOD LIGHT

(OC) DENOTES OCCUPANCY SENSOR

(CF) DENOTES COMPACT FLUORESCENT

ELECTRICAL LEGEND

ONE-LINE DIAGRAM

PANEL '		1 / 1	_240	/120	_ VOLT,	1 PHAS	E, <u>3</u> V	VIRE	LUGS ONLY	JIE:					
			AM	IP BUS,		KAIC RATII	KAIC RATING CB AM								
CCT.	AD	С	В	LOAD D	NESCOIL	IAOITC		PHASE	VA LOAD	1.0	OAD DESCRIPTION	С	В	AD	CCT.
#	0	Р	Т	LOAD L	LOUNII	TION		ØA	ØB		JAD DESCRIPTION	Р	Т	9	#
1	LTG	1	20	LIGHTS				4877		HV	AC ASSEMBLY AREA	2	$\overline{\mathcal{L}}$	М	2
3	LTG	1	20	EMERGE	NCY/EX	(IT LIGH	ITS		4675				30		4
5	REC	1	20	BATHRO	OM REC	CEPTAC	CLES	4960		HV	AC LOCKER ROOM	2		М	6
7	REC	1	20	LOCKER	LOCKER ROOM RECEPTACLES				5050				30		8
9	REC	1	20	DRINKING FOUNTAIN				522		REC	COVERY VENTILATOR	1	15	М	10
11	REC	1	20	LOUNGE RECEPTACLES					1080						12
13															14
15															16
17															18
19															20
21															22
23															24
00	VIDI.	TION	-	MOLIN	ITINIC	SUBT	OTAL	10359	10805		E	NCLOS	SUR	=	
ME NE	CONDITION  NEW			MOUNTING TOTAL CONI				NECTED LC S LOAD + 2	A	□ NEMA 1 NEMA 3F					
EX	(ISTI)	ΝG		FLUSH TOTAL LOAD 21539 VA / 24			)	215	39 V	A TYP	E:				

PANEL SCHEDULE LEGEND

T = TRIP AMP.G = GENERAL RECEPTACLE P = POLES HANDLE LOCK ON DEVICES

REC = RECEPTACLES (LOCKED IN CLOSE POSITION) LTG = LIGHTING ● ● = HANDLE LOCK OFF DEVICES C = CONTINUOUS LOAD (LOCKED IN OPEN POSITION) D = DEDICATED RECEPTACLE = AMPERES

CB = CIRCUIT BREAKER M = MECHANICAL LOAD

KA = 1,000 AMPERES

KVA = 1,000 VOLT AMPERES

THIS DRAWING IS NOT FINAL AND IS NOT TO BE USED FOR CONSTRUCTION JNTIL STAMPED AND WET-SIGNED BY THE PROJECT ENGINEER. struction contractor agrees that in accordance with generally accepted construction practices, construction ntractor will be required to assume sole and complete responsibility for job site conditions during the course of onstruction of the project, including safety of all persons and property; that this requirement shall be made to apply ontinuously and not be limited to normal working hours, and construction contractor further agrees to defend, indemnify and hold design professional harmless from any and all liability, real or alleged, in connection with the performance of work on this project, excepting liability arising from the sole negligence of design professional.

REVISIONS =

VEATHERBY-REYNOLDS-FRITSON

(209)-223-0716 [Fax] 206 Peek Street Jackson, CA. 95642 nttp://www.wrfed.com

(MS) DENOTES MOTION SENSOR W/ PHOTOCELL

(VS) DENOTES VACANCY SENSOR

MBODIED THEREIN ARE THE ORIGIN UNPUBLISHED WORK OF WRF HE WRITTEN AGREEMENT OF T WEATHERBY, GRANT REYNOLDS, ( KEVIN FRITSON

DRAWINGS POWER PLAN, LIGHTING PLAN AND SCHEDULES

> D-7467 FILE NO. DRAWN BY 01-2019 SCALE AS NOTED

8 OF 9 SHEETS

(20) POWER PLAN

SCALE: 1/4" = 1'-0

(12) ELECTRICAL PANEL SCHEDULE

